PROJECT DESCRIPTION

THIS PROJECT PROPOSES ALTERATIONS TO AN EXISTING 1111SF TWO-BEDROOM, SPLIT-LEVEL (HOME. (THIS SF INCLUDES A 187SF GARAGE).

THIS PROJECT PROPOSES TO RAISE AN EXISTING SPLIT-LEVEL HOME, MAKING IT A FULL TWO-LEVEL THE RAISED STRUCTURE WILL BECOME THE NEW SECOND LEVEL AND CONTAIN A 400SF JUNIOR AN OWN ENTRANCE FROM THE STREET) AS WELL AS TWO BEDROOMS AND ONE BATHROOM AS PART (HOUSE. THE NEW GROUND FLOOR WILL INCLUDE NEW AND EXPANDED LIVING, DINING, AND KITCHEN ALONG WITH A NEW MASTER SUITE AND AN EXPANDED GARAGE. AN ADDITION BEYOND THE EXIST OF THE BUILDING WILL BE CONSTRUCTED IN THE REAR OF THE NEW GROUND LEVEL TO PROVIDE FOR ENOUGH ACCESSIBLE MASTER SUITE ON THAT LEVEL


IN ADDITION TO LIFTING THE EXISTING HOUSE, THE STRUCTURE WILL BE MOVED TO THE EAST, (AWA STREET AND INTO THE BACKYARD) BY 3 FEET, INCREASING OUR FRONT YARD SETBACK FROM 18'-THIS INCREASED SETBACK FROM THE STREET WILL CREATE MORE SPACE FOR OFF STREET PARKIN PROVIDE FOR A LARGER FRONT YARD. EXISTING SIDE YARD SETBACKS OF JUST OVER 3 FEET WILL MAINTAINED.


SINCE THE EXISTING MAIN LEVEL IS APPROXIMATELY 4 FEET FROM EXISTING GRADE THE HOME ONI BE RAISED 7'-4" TO ACHIEVE A NEW GROUND LEVEL CEILING HEIGHT OF 10 FEET. PLEASE SEE SHE SEE HOW NICELY THE PROPOSED DESIGN FITS IN THE STREETSCAPE. THE NEW ROOF RIDGE HEIGHT FEET.

TECHNICALLY SPEAKING **WE ARE ACTUALLY PROPOSING TO ADD ONE LEGAL PARKING SPACE.** TH THE FACT THAT THE EXISTING GARAGE IS ONLY 16 FEET DEEP AND THUS DOES NOT QUALIFY AS A LEGAL SPACE. OUR PROPOSED GARAGE IS A FULL 19 FEET DEEP BY ALMOST 11 FEET IN WIDTH AN FOR A FULL, LEGAL PARKING SPACE.

AS MENTIONED, WE ARE ALSO PROPOSING A LARGER FRONT YARD IN PART TO ALLOW FOR MORE SOFT-STREET PARKING SPACE IN THE DRIVEWAY. WHILE NOT LEGAL IF IN THE FRONT YARD, DRIVEWAY BOTH THE STANDARD METHOD OF PARKING IN THE NEIGHBORHOOD AND A CRITICAL COMPONENT OF FUNCTIONAL NEIGHBORHOOD PARKING IN ALBANY.

	PROJECT DATA		
(TWO STORY)	APN: LOT SIZE: ZONING DISTRICT:	65-2644-53 3743 SF R-1	
EL RESIDENCE. ADU (WITH ITS T OF THE MAIN	CONSTRUCTION TYPE:	V-5	
IN SPACES TING FOOTPRINT	TOTAL EXISTING FLOOR AREA (INC. GARAGE):	1111 SF	
OR A LARGE	ADDITIONAL FLOOR AREA PROPOSED:	921 SF	
AY FROM THE	TOTAL PROPOSED FLOOR AREA (INC. GARAGE):	2032 SF	
3'-6" TO 21'-6". .ING AND .L BE	MAXIMUM ALLOWABLE FLOOR AREA: 3743SF X 0.55 (FAR)	2059 SF	Table Are Region Are Albany Library Sarane Door Repair
NLY NEEDS TO	PROPOSED FAR RATIO: 2032SF / 3743SF	0.54	Mosaic Marin Ave Marin Ave Little Bears Daycare
IEET A 0.2 TO HT WILL BE 27	NO. OF STORIES EXISTING: NO. OF STORIES PROPOSED:	2 2	Jingle Jamboree Music Tota Are Comell Are Comell Are
HIS IS DUE TO AN EXSITING	APPLICABLE BUILDING COD	DES	Cornell Are
SPACE FOR AN VAY PARKING IS OF	2019 CALIFORNIA FIRE CODE 2019 CALIFORNIA PLUMBING CODE 2019 CALIFORNIA ELECTRICAL CODE 2019 BUILDING ENERGY EFFICIENCY STANDAR 2019 CALIFORNIA GREEN BUILDING STANDARI		
	PROJECT DIRECTORY		<u>GENERAL</u>
	<u>OWNER</u> JEROME RAINEY AND JEAN MCANENY 1019 KEY ROUTE BLVD, ALBANY, CA 94706		AO.O COVEI AO.1 GENE AO.2 EXIST
	ARCHITECT		ARCHITECTUR
	TODD JERSEY, AIA TODD JERSEY ARCHITECTURE INC. 1321 8TH STREET, SUITE #2 BERKELEY, CA 94710 TODD@TODDJERSEYARCHITECTURE.COM (510) 334 - 3626		A1.0E EXISTI A1.1E EXISTI A2.0E EXISTI A2.1E EXISTI A1.0 PROPO A1.1 PROPO
	<u>LAND SURVEYOR</u> ROBERT J. DAINS, L.S. 8227 DAINS LAND SURVEYING (650) 743 - 0831 RDAINS@DAINSLANDSURVEYING.NET		A1.2 PROPC A2.0 PROPC A2.1 PROPC A2.2 PROPC A3.0 PROPC A3.1 PROPC
	<u>TITLE 24</u>		A3.2 PROPO A4.0 PROPO
	T.B.D.		LAND SURVE
	STRUCTURAL		LAND SURVE

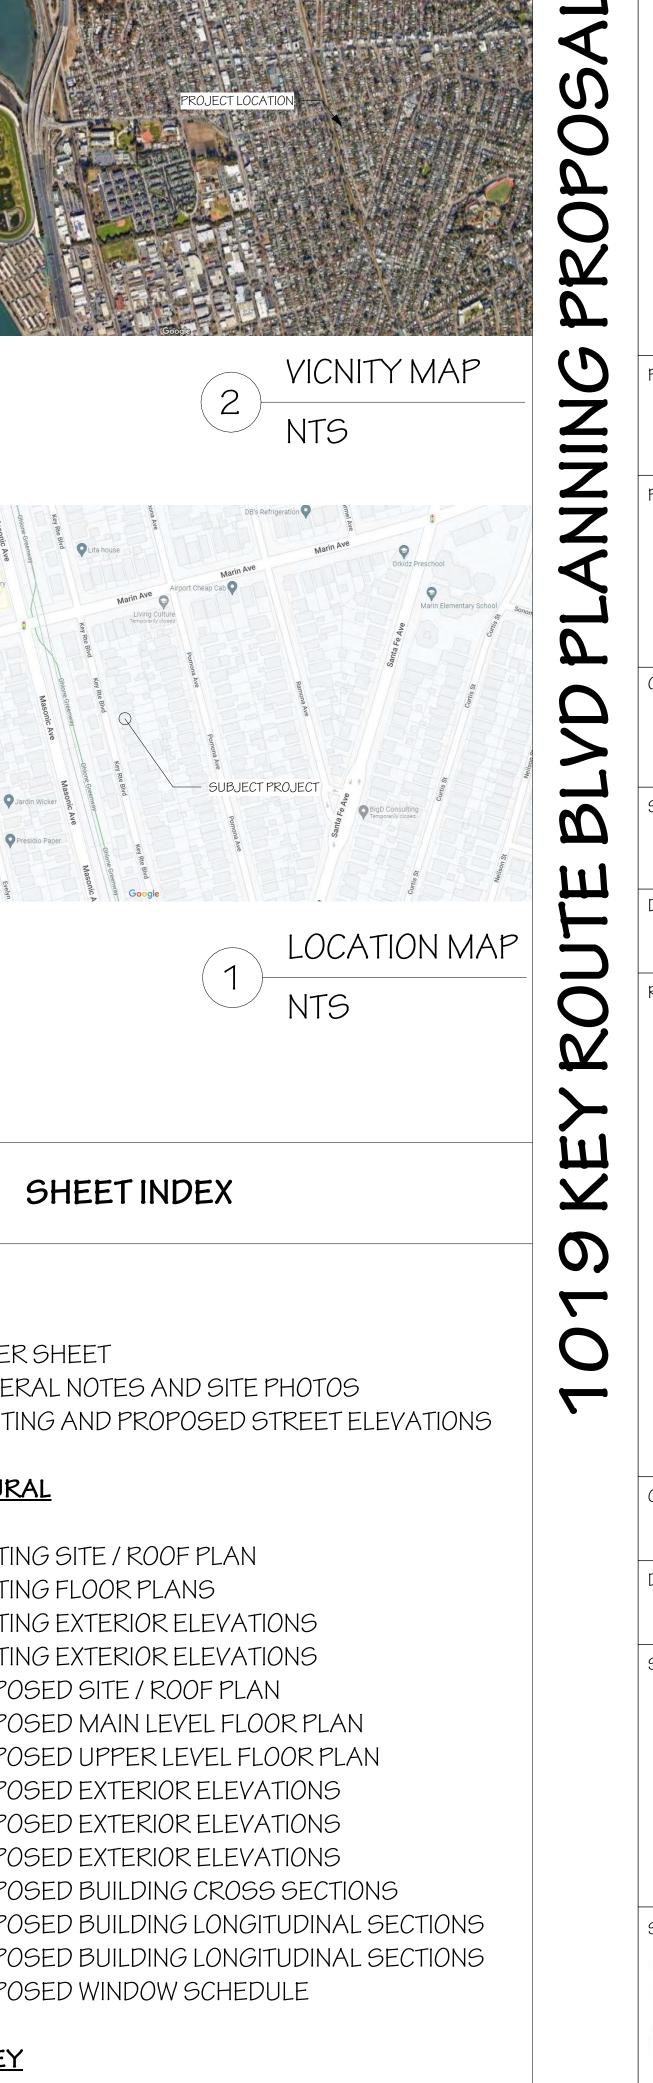

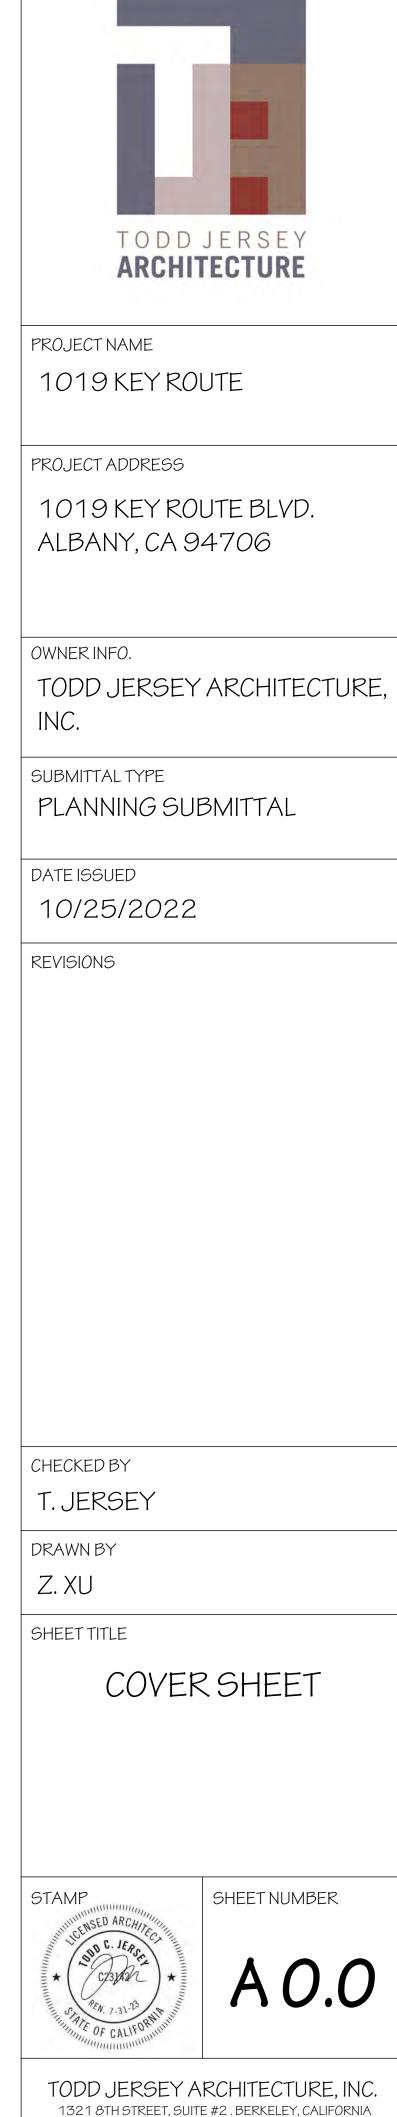

(510) 528-5477 WWW.TODDJERSEYARCHITECTURE.COM

SURVEY

ABBREVIATIONS

BLDG. BTWN

CL CLR CONC CONT

D.F.

D.S. DTL D/W (E)

EQ

F.C.W.

F.F. F.F.W. FIN

FLR

FND

F.O.C.

F.O.F.

F.0.S. G.S.M.

GALV G.W.B INSUL

MAX MIN

MIRR

M.F.I.

MTL (N)

N.I.C.

N.T.S.

O.C.

P.L.

P.T. RDWD

REF

R.O.

SF S.G.D. SIM

S.O.G. S.S.D.

Т.О.

TYP

T.O.W.

V.I.F. W/


W.P.

BUILDING
BETWEEN
CENTER LINE
CLEAR
CONCRETE
CONTINUOUS
DOUGLAS FIR
DOWNSPOUT
DETAIL
DISHWASHER
EXISTING
EQUAL
FRONT CASEMENT WINDOW
FINISHED FLOOR
FACE OF FINISH WALL
FINISH
FLOOR
FOUNDATION
FACE OF CONCRETE
FACE OF FRAMING
FACE OF STUD
GALVANIZED SHEET METAL
GALVINIZED
GYPSUM WALL BOARD
INSULATION
MAXIMUM
MINIMUM
MIRRORED
MINERAL FIBER INSULATON
METAL
NEW
NOT IN CONTRACT
NOT TO SCALE
ON CENTER
PROPERTY LINE
PRESSURE TREATED
REDWOOD
REFRIGERATOR
ROUGH OPENING
SQUARE FEET
SLIDING GLASS DOOR
SIMILAR
SLAB ON GRADE
SEE STRUCTURAL DRAWINGS
TOPOF
TYPICAL

TOP OF WALL VERIFY IN FIELD

WATER PROOFING

WITH

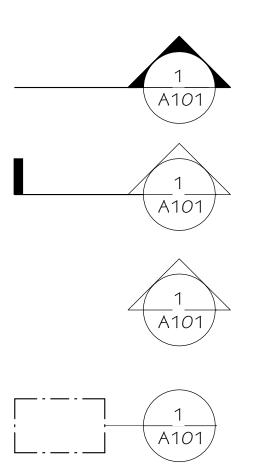

01

А

SYMBOLS

BUILDING SECTION

WALL SECTION

BUILDING ELEVATION

DETAIL CALLOUT

KEYNOTE TAG

WINDOW TAG

DOORTAG

PROJECT NORTH(PN) TRUE NORTH (N)

ELEVATION LEVEL

Name 🖉 Elevation

(*O*)-----

GRID LINE

HIDDEN LINE BELOW

HIDDEN LINE ABOVE

DEMOLITION LINE


_ _ _ _ _ _ _ _ _

PROPERTY LINE







1. (E) FRONT FACADE

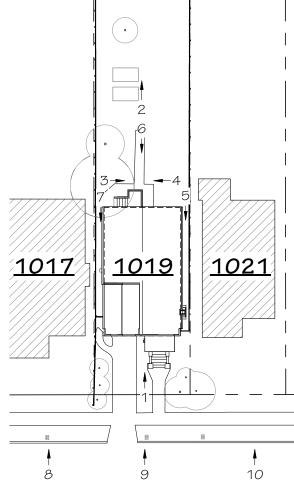

REFERENCE PLAN

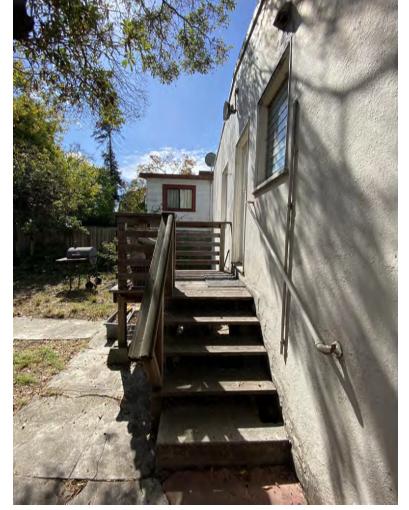


3. (E) BACKYARD FACING SOUTH

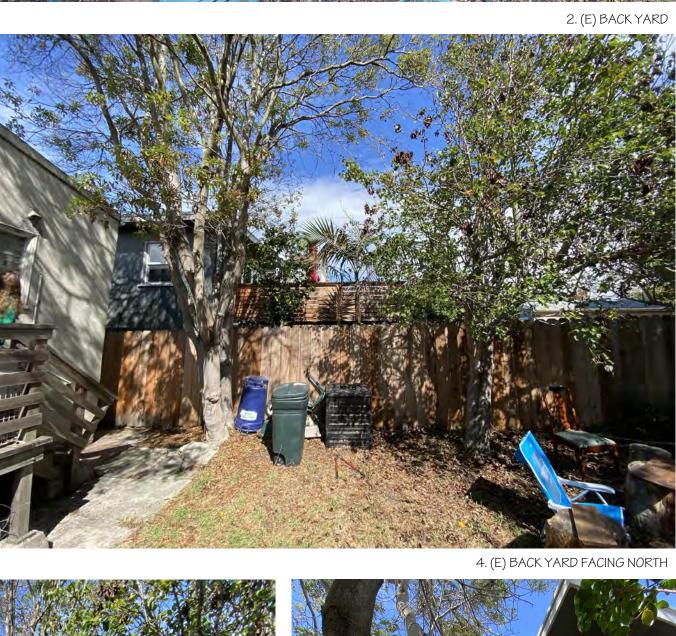



5. (E) SOUTH SIDEYARD

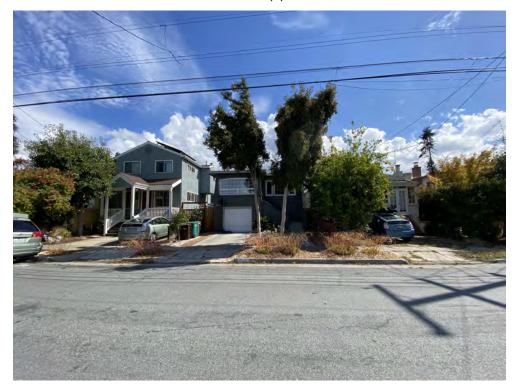

8. STREET ELEVATION SHOWING 1017 KEY ROUTE BLVD.






9. STREET ELEVATION SHOWING 1019 KEY ROUTE BLVD.

$\frac{1}{1} \frac{\text{SITE PHOTOGRAPHIC SURVEY}}{\text{NTS}}$

10. STREET ELEVATION SHOWING 1021 KEY ROUTE BLVD.

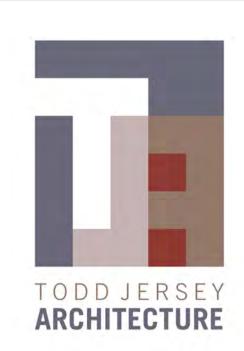

PROJECT NAME 1019 KEY ROUTE

PROJECT ADDRESS

1019 KEY ROUTE BLVD. ALBANY, CA 94706

OWNER INFO. TODD JERSEY ARCHITECTURE, INC.

SUBMITTAL TYPE PLANNING SUBMITTAL

DATE ISSUED 10/25/2022

REVISIONS

CHECKED BY

T. JERSEY

DRAWN BY

Z. XU

SHEET TITLE

STAMP

GENERAL NOTES AND

SITE PHOTOS

TODD JERSEY ARCHITECTURE, INC.


1321 8TH STREET, SUITE #2 . BERKELEY, CALIFORNIA (510) 528-5477 WWW.TODDJERSEYARCHITECTURE.COM

SHEET NUMBER

A 0.1




1017 KEY ROUTE BLVD.

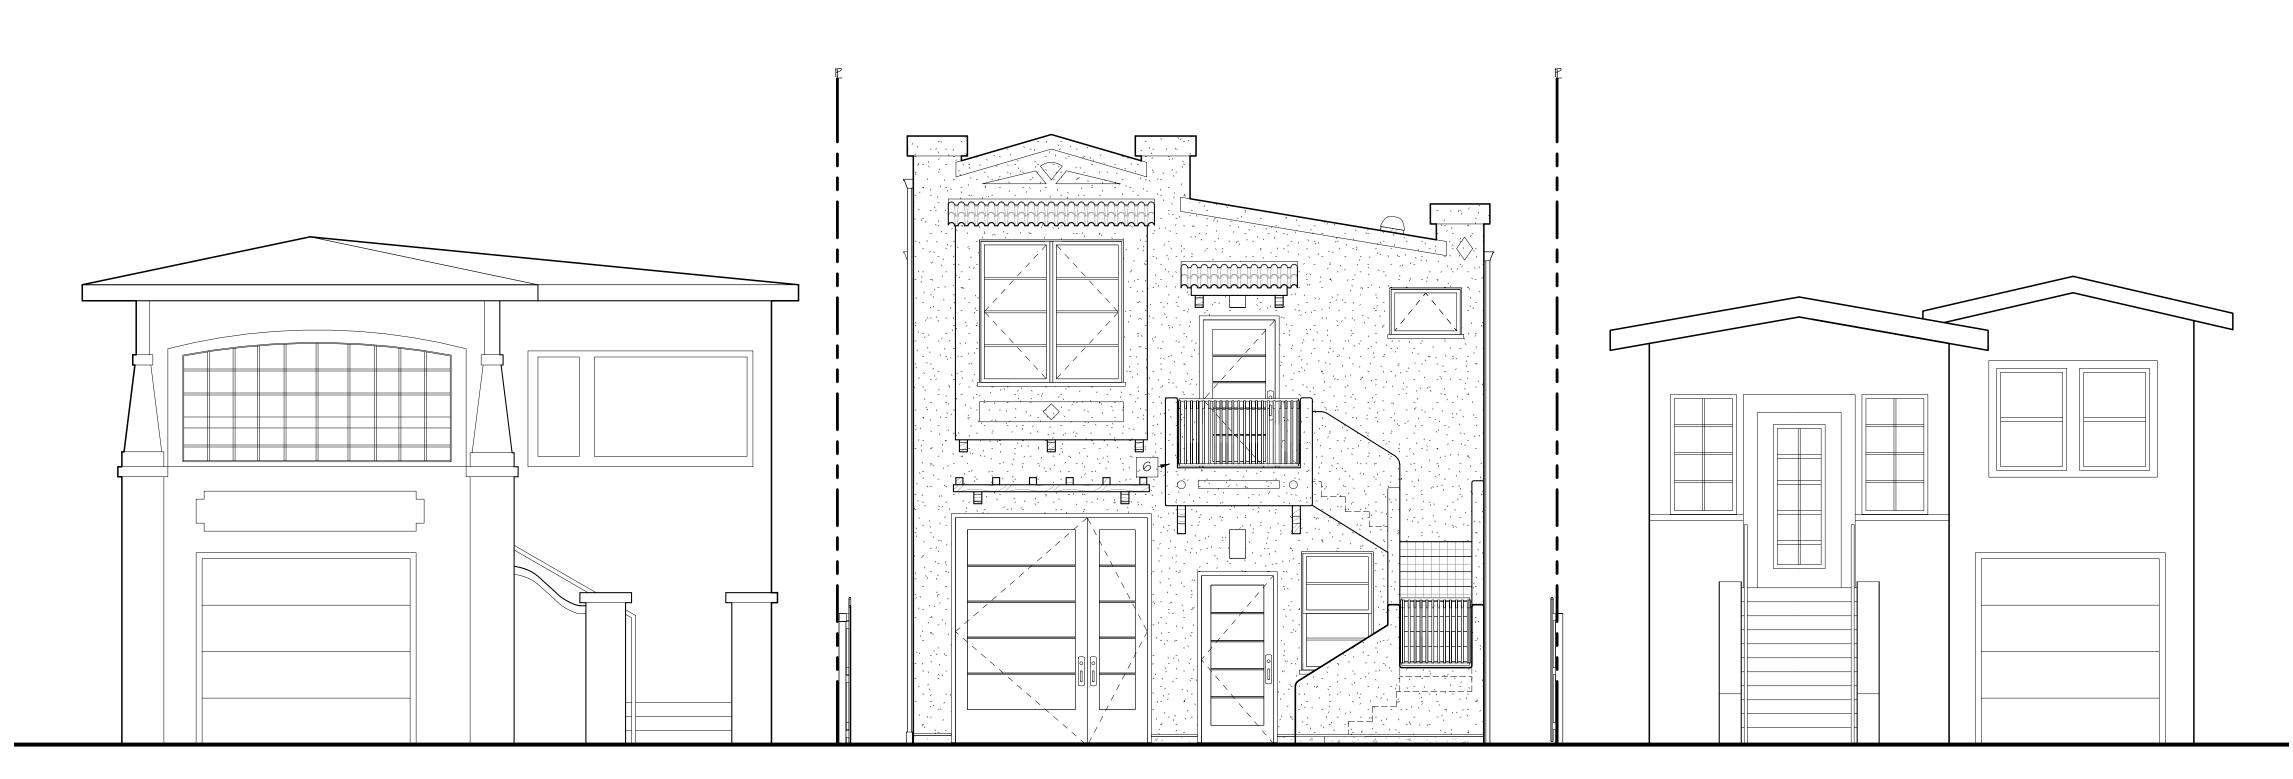

1017 KEY ROUTE BLVD.

1019 KEY ROUTE BLVD.

1019 KEY ROUTE BLVD.

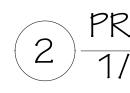


$2 \frac{\text{PROPOSED STREET ELEVATION}}{1/4" = 1'-0"}$

1021 KEY ROUTE BLVD.

$1 \frac{\text{EXISTING STREET ELEVATION}}{1/4" = 1'-0"}$

1021 KEY ROUTE BLVD.

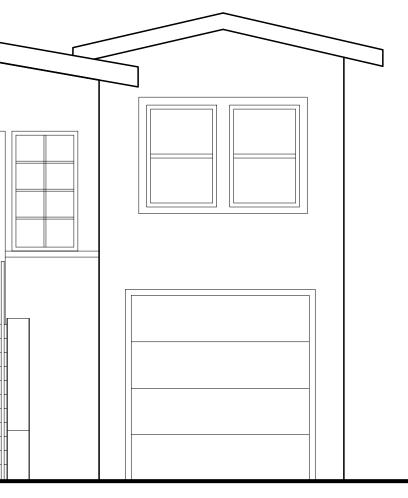



PROJECT NAME 1019 KEY ROUTE

PROJECT ADDRESS

DATE ISSUED

REVISIONS

CHECKED BY

DRAWN BY

Z. XU

STAMP

SED ARC

SHEET TITLE

(E) & (P) STREET ELEVATION

TODD JERSEY ARCHITECTURE, INC.

1321 8TH STREET, SUITE #2. BERKELEY, CALIFORNIA (510) 528-5477 WWW.TODDJERSEYARCHITECTURE.COM

SHEET NUMBER

A 0.2

T. JERSEY

10/25/2022


1019 KEY ROUTE BLVD. ALBANY, CA 94706


SUBMITTAL TYPE PLANNING SUBMITTAL

TODD JERSEY ARCHITECTURE,

INC.


OWNER INFO.

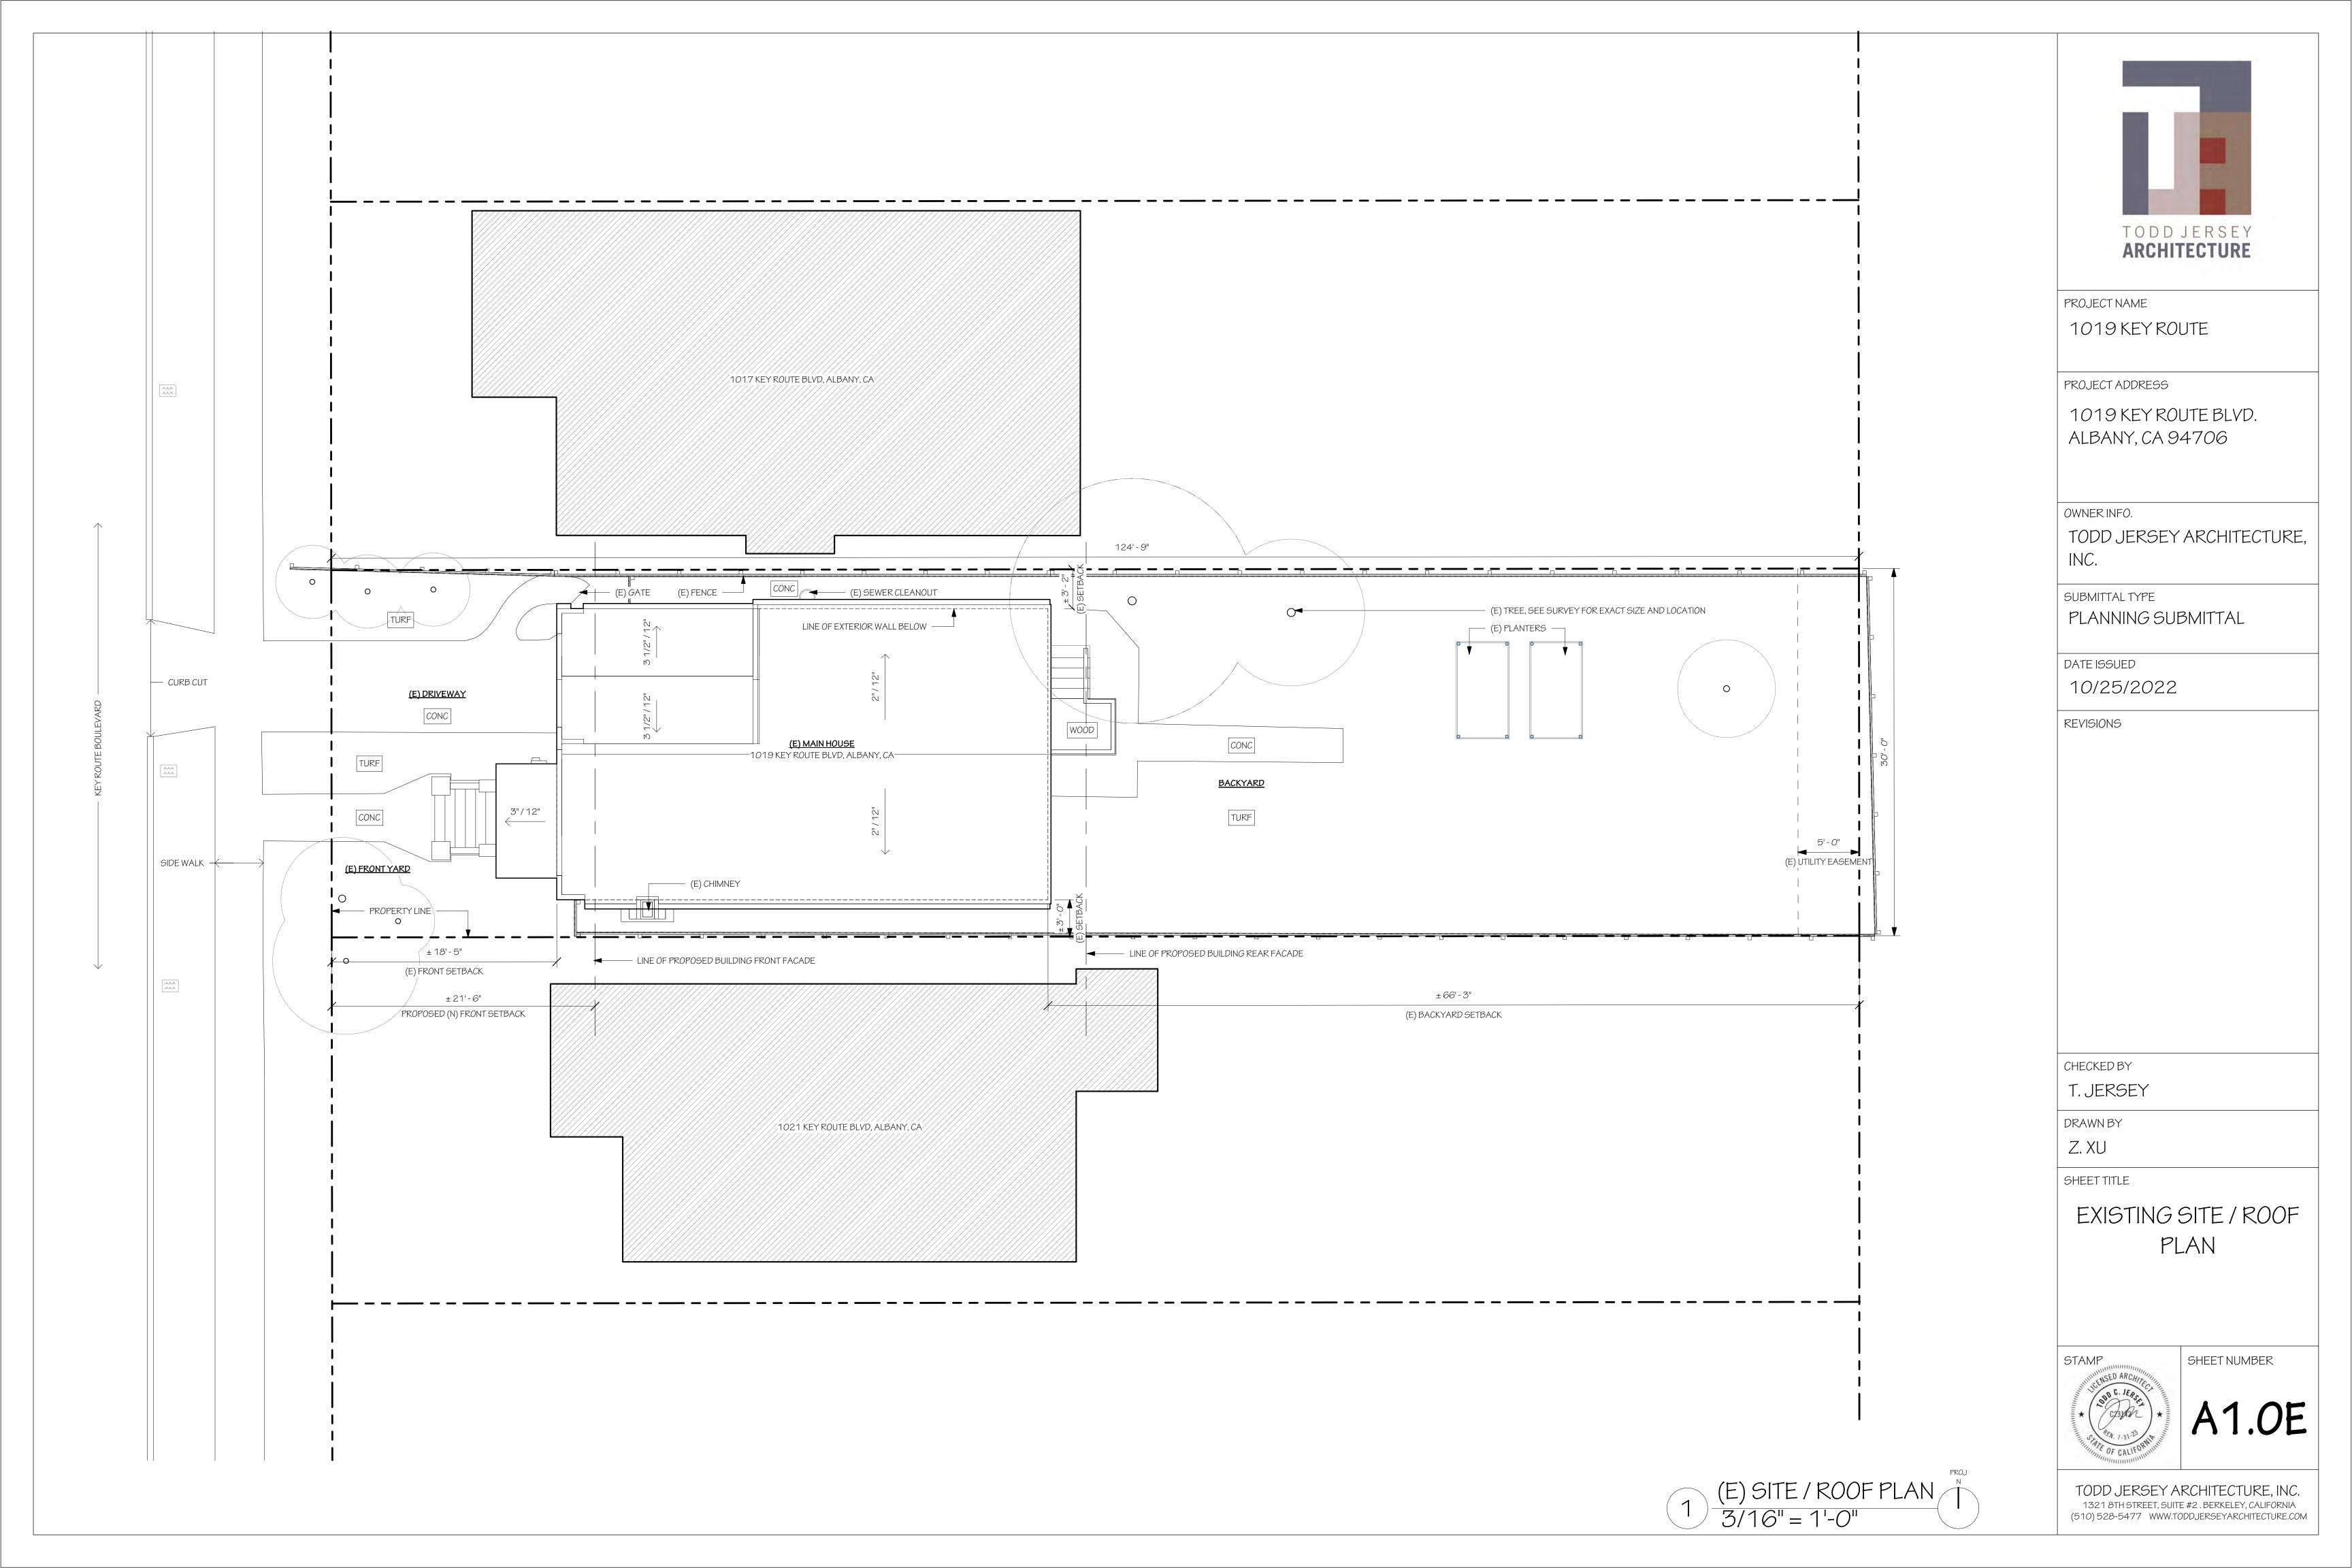


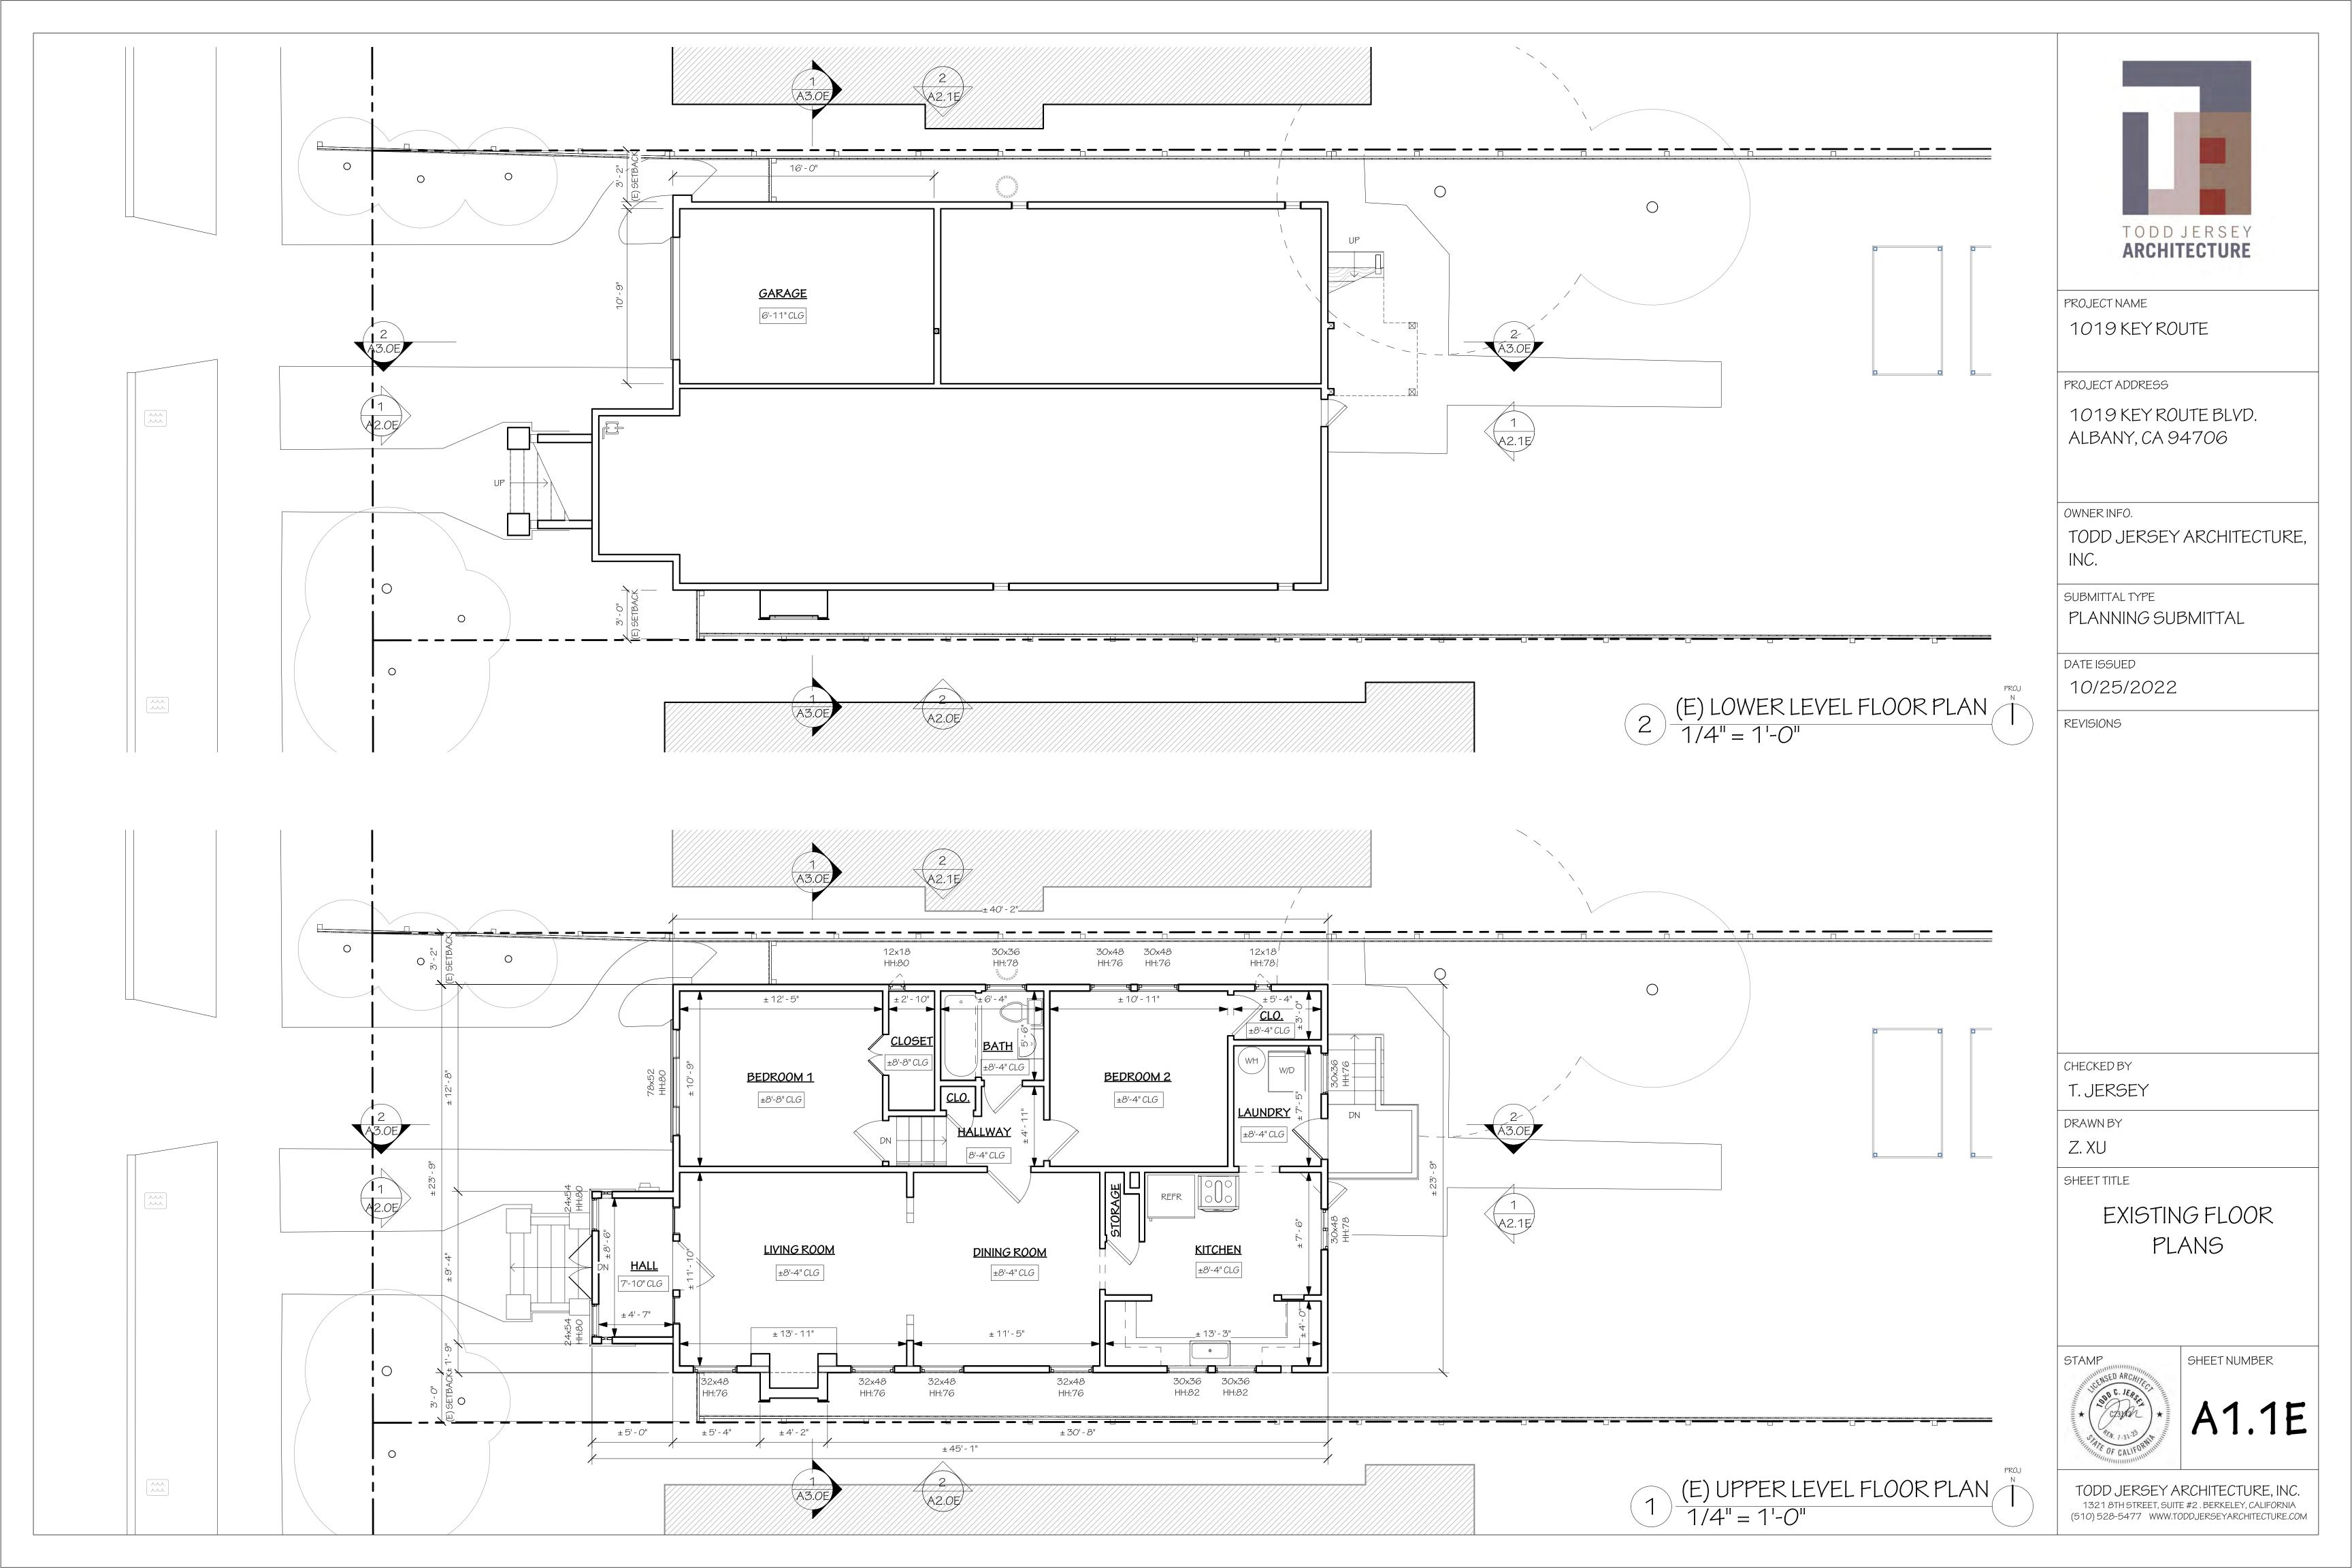







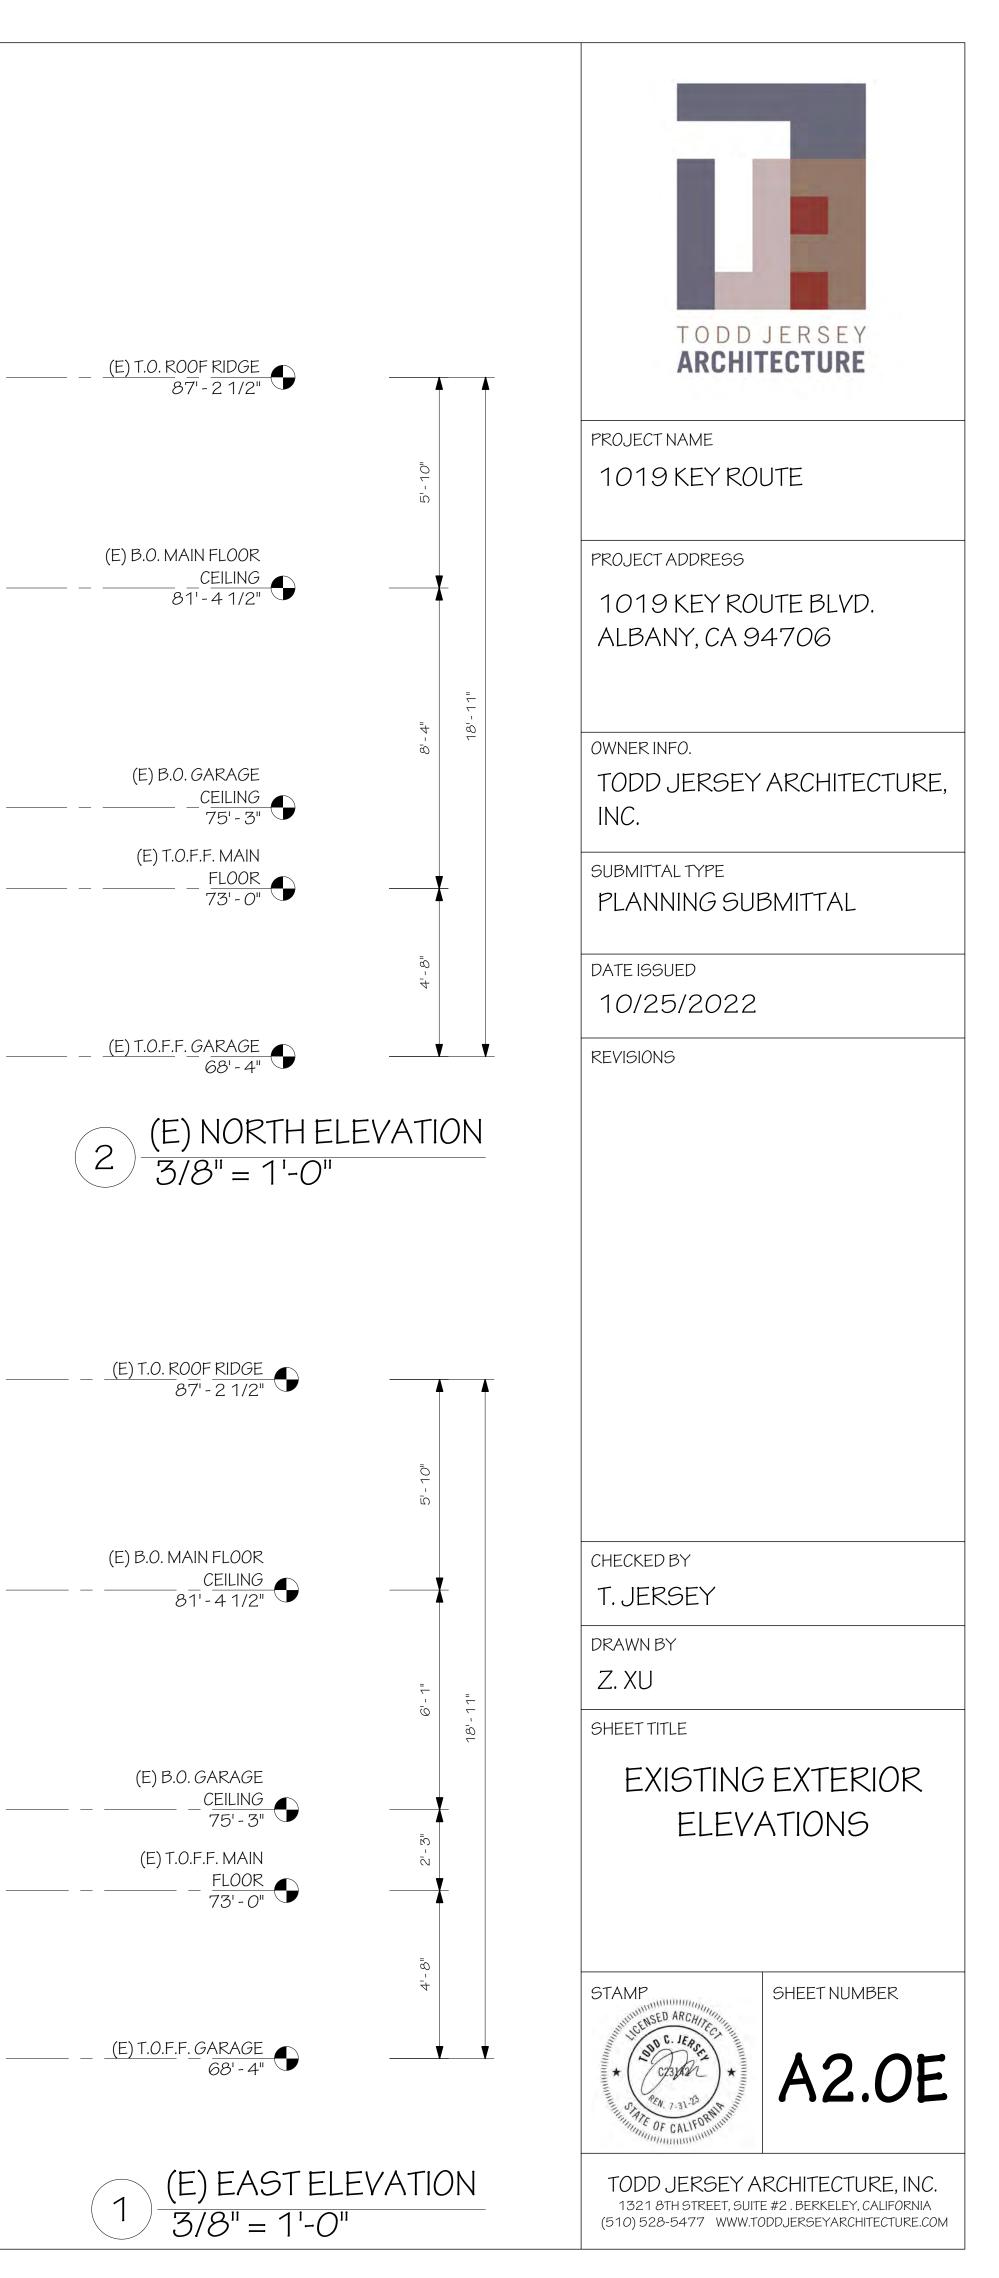


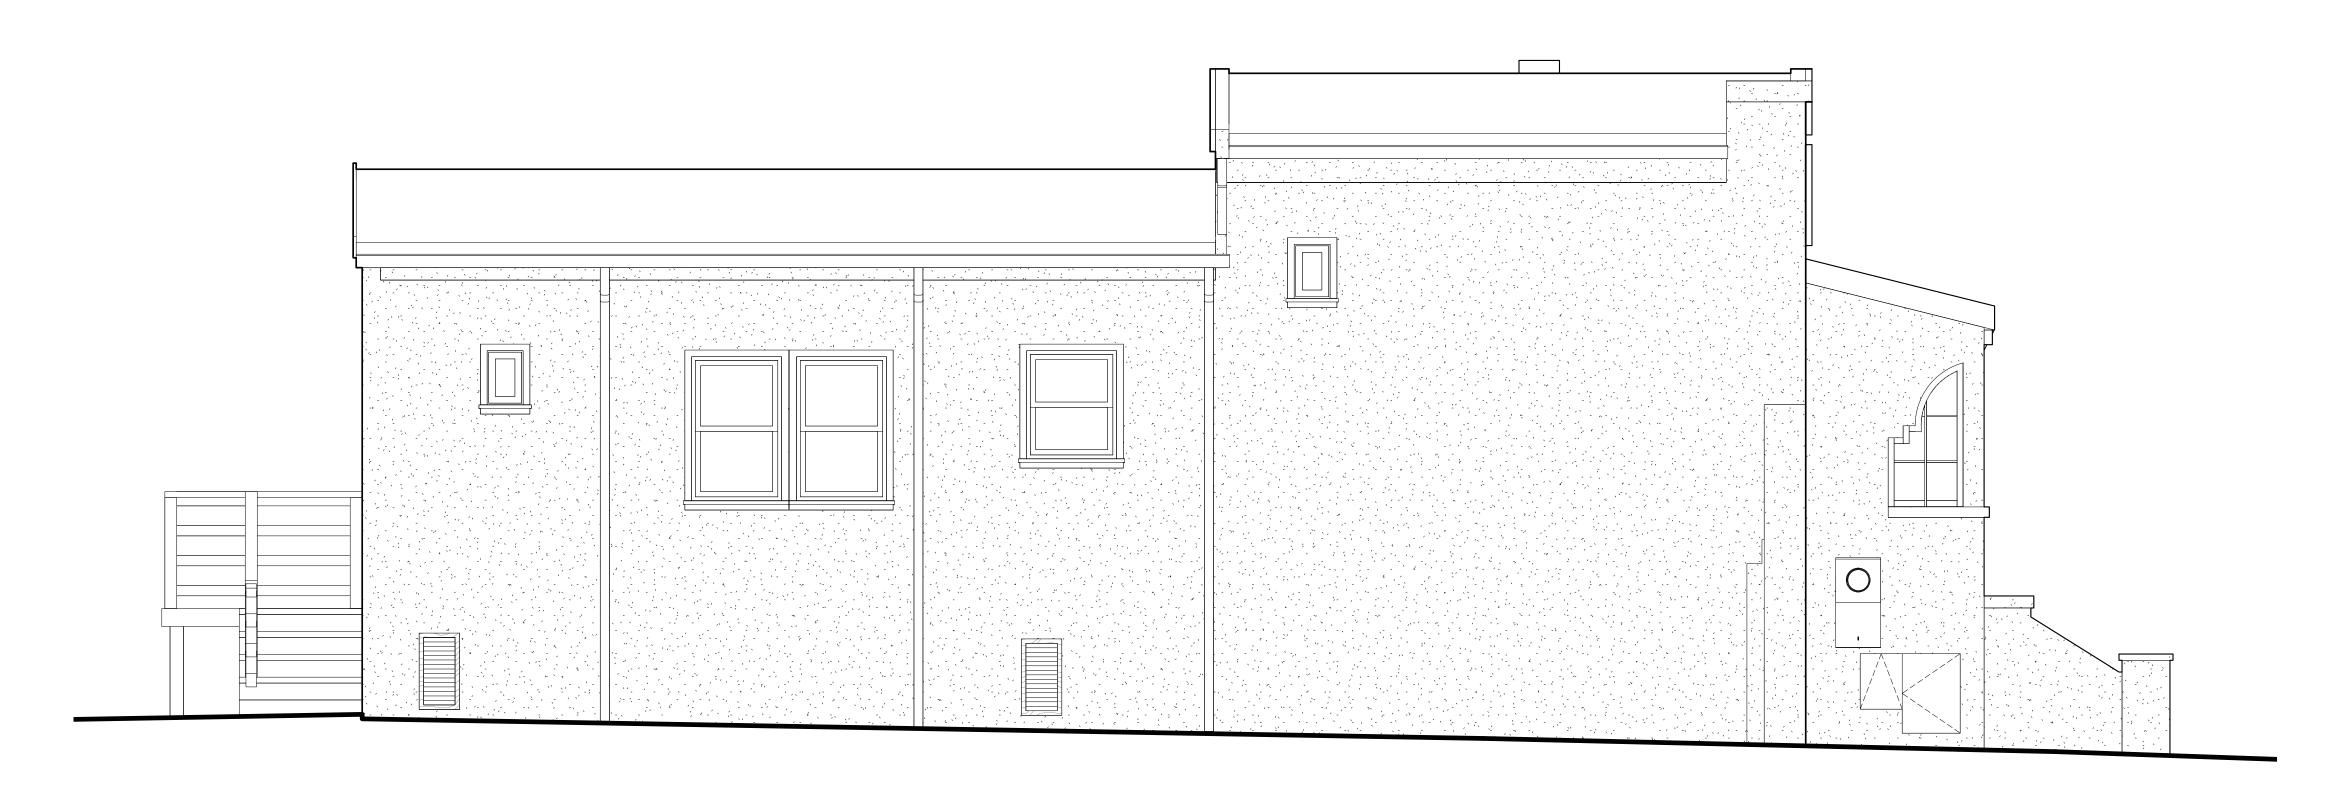




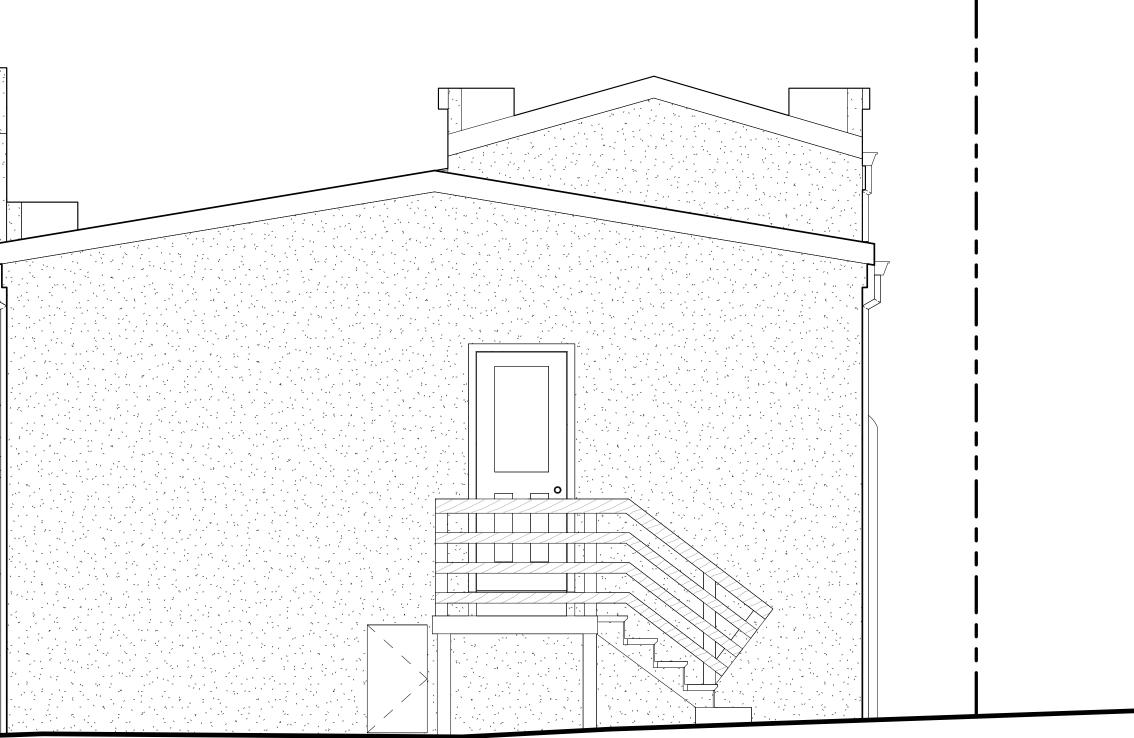


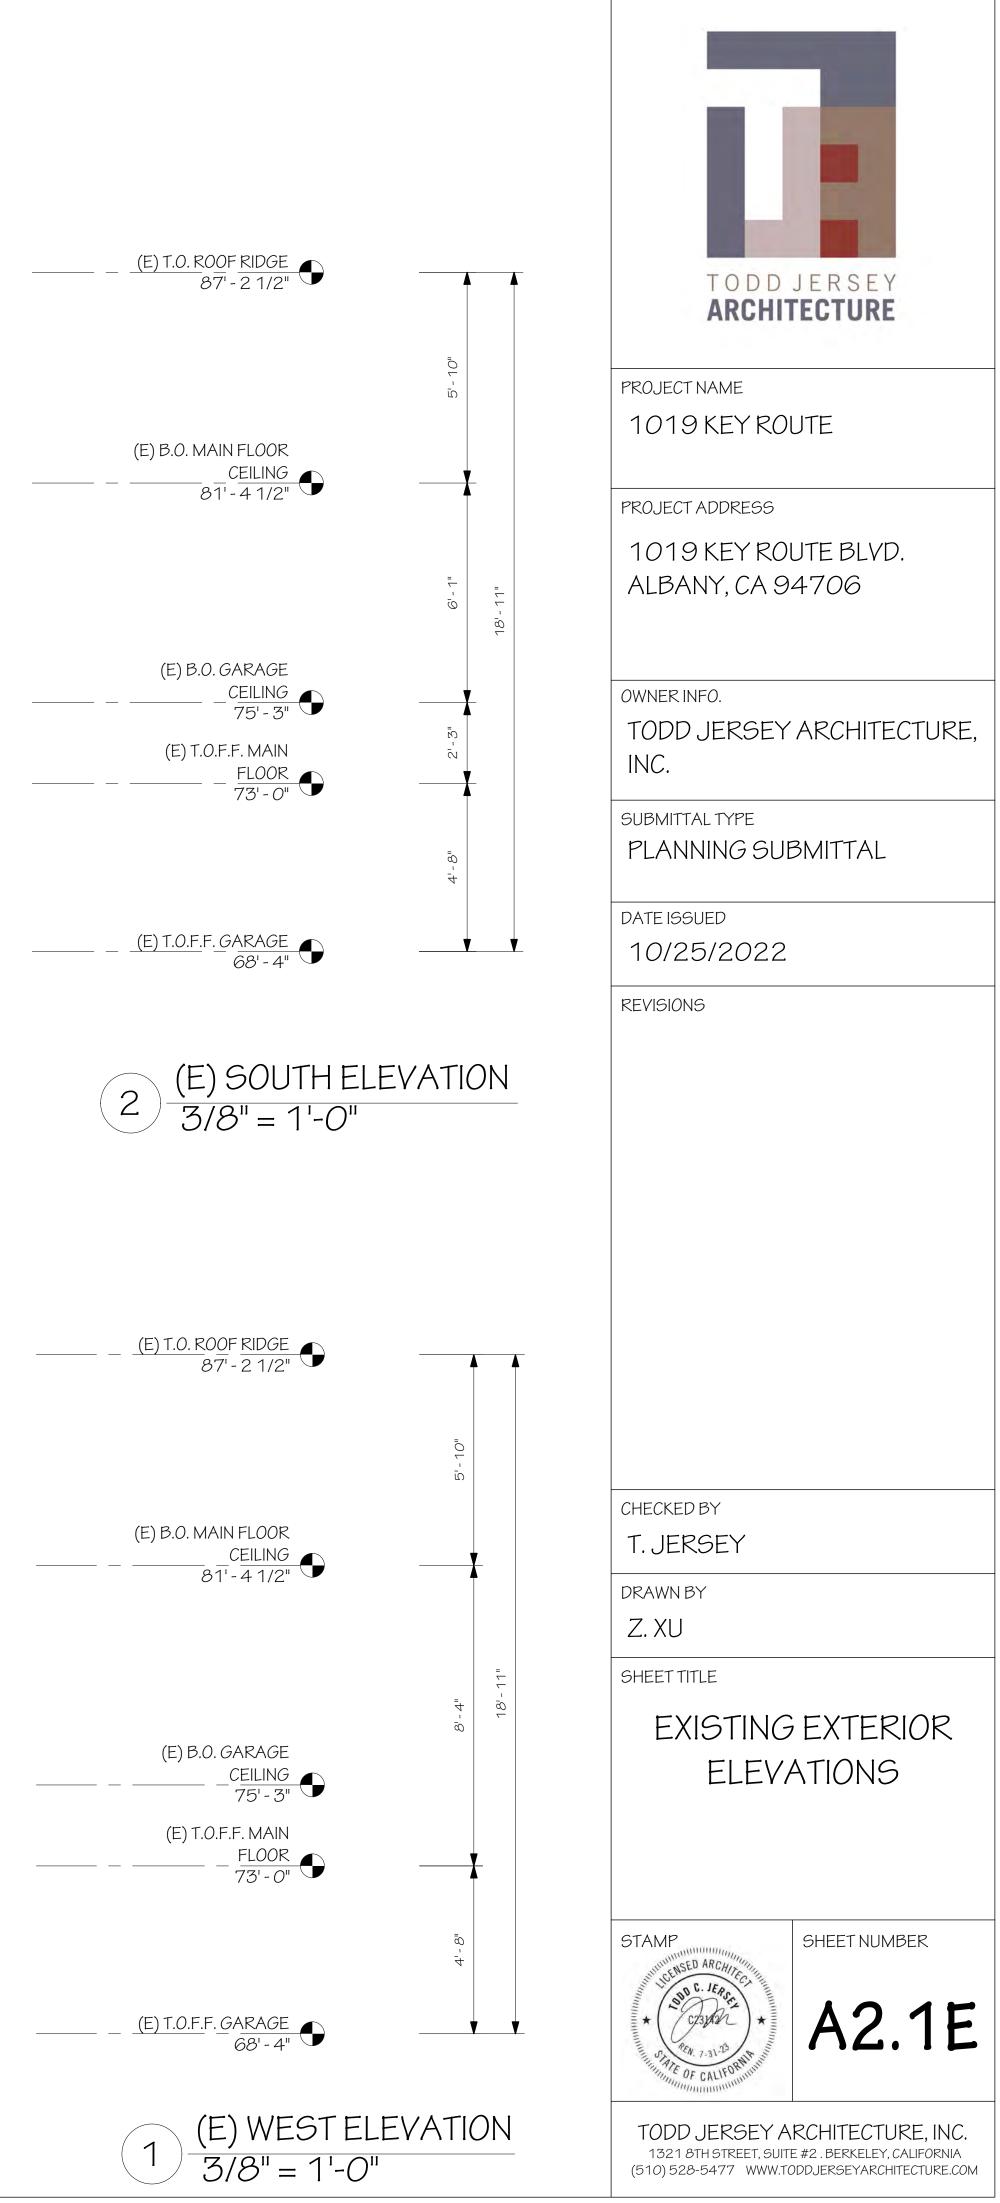


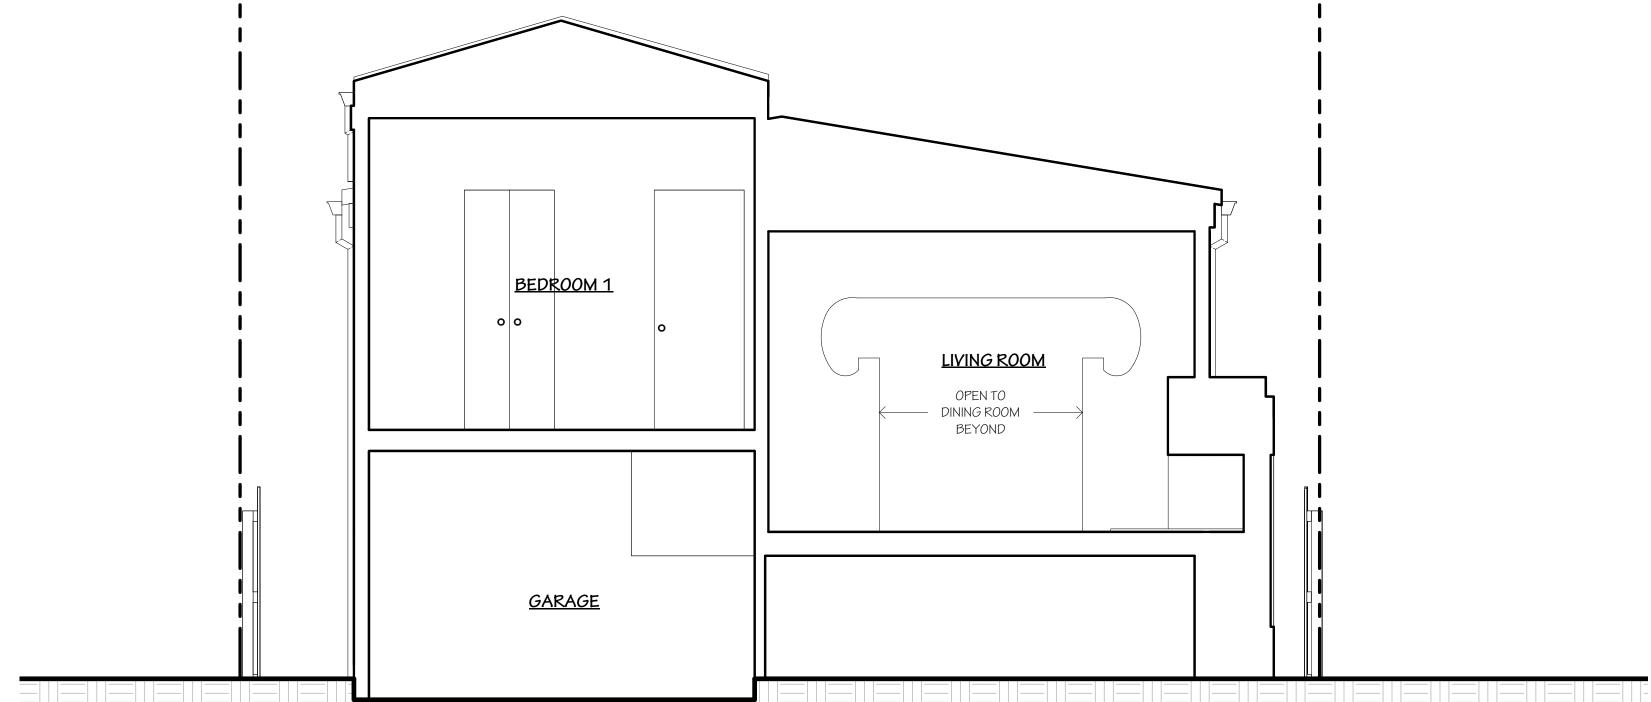

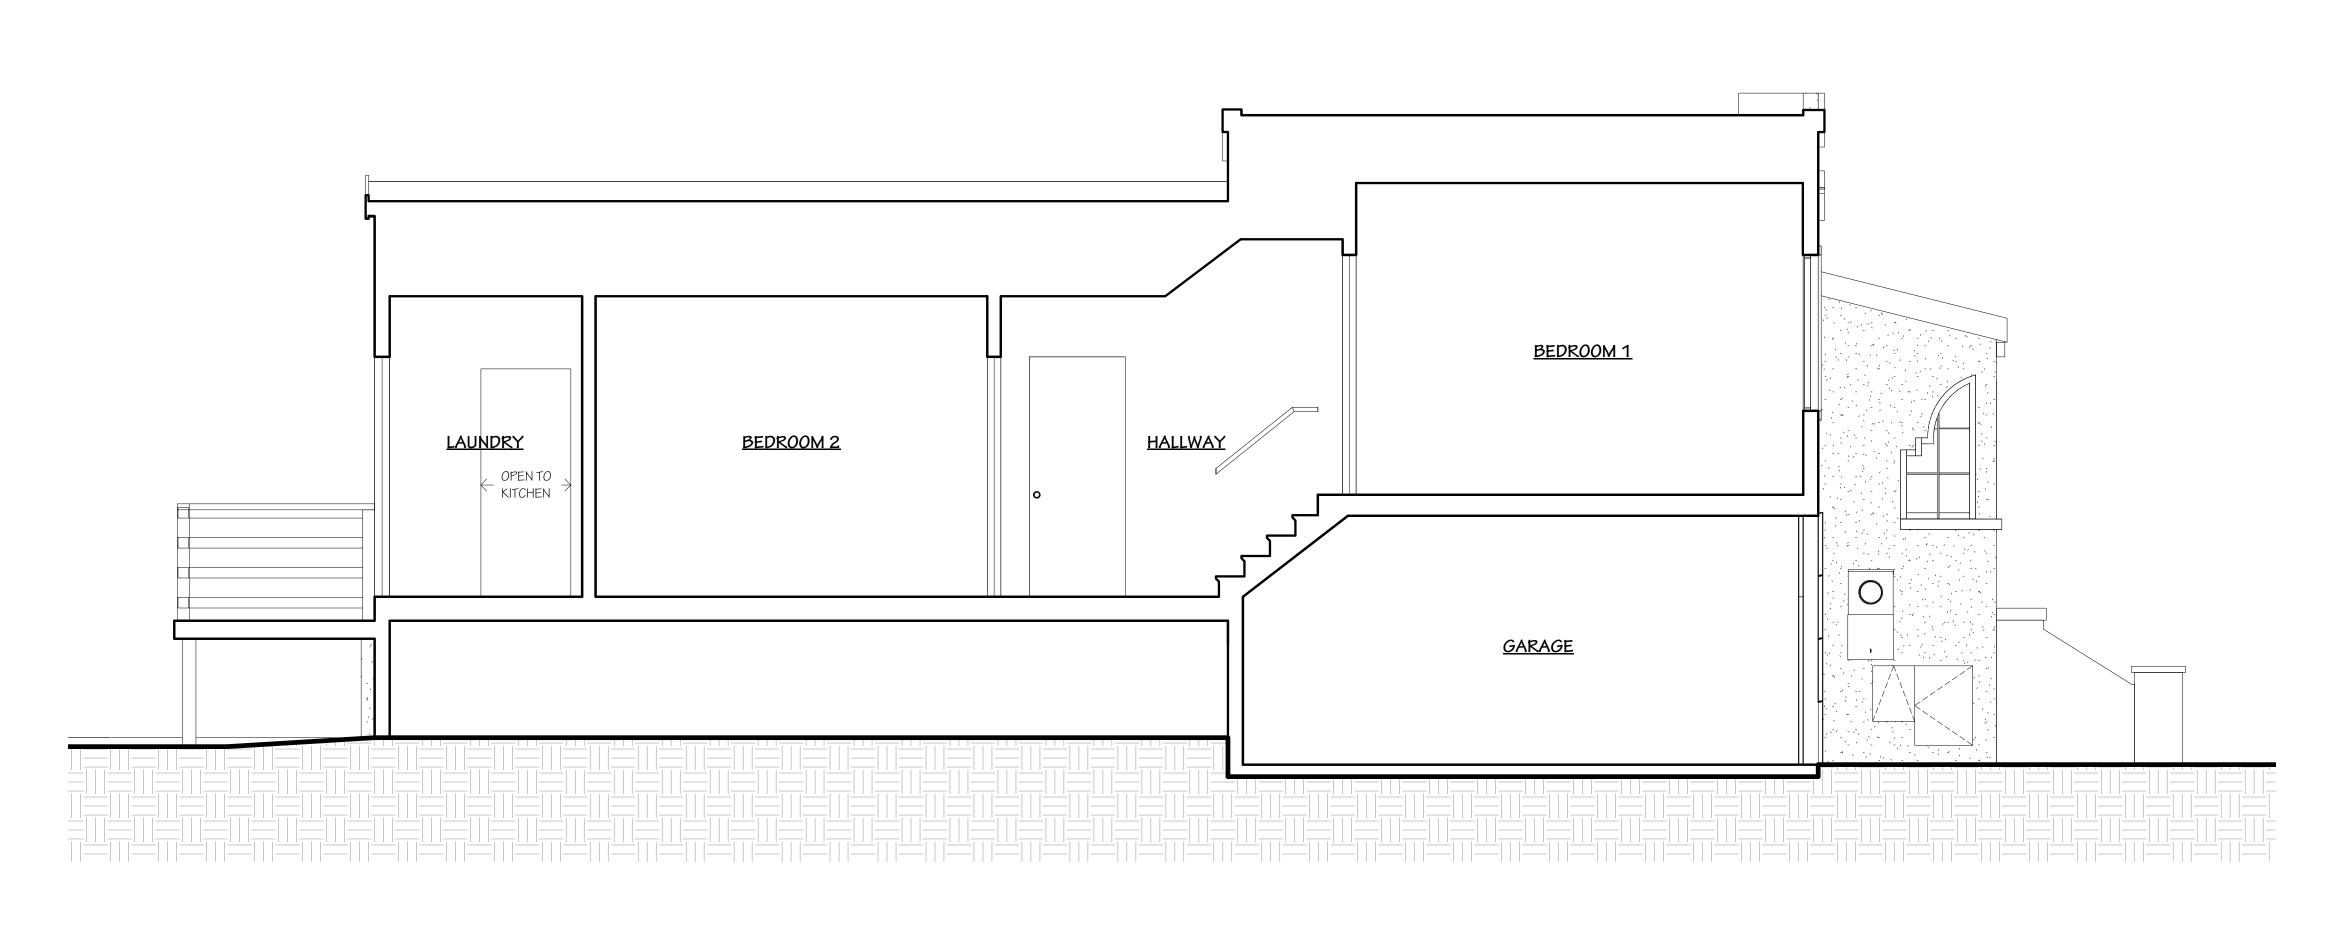




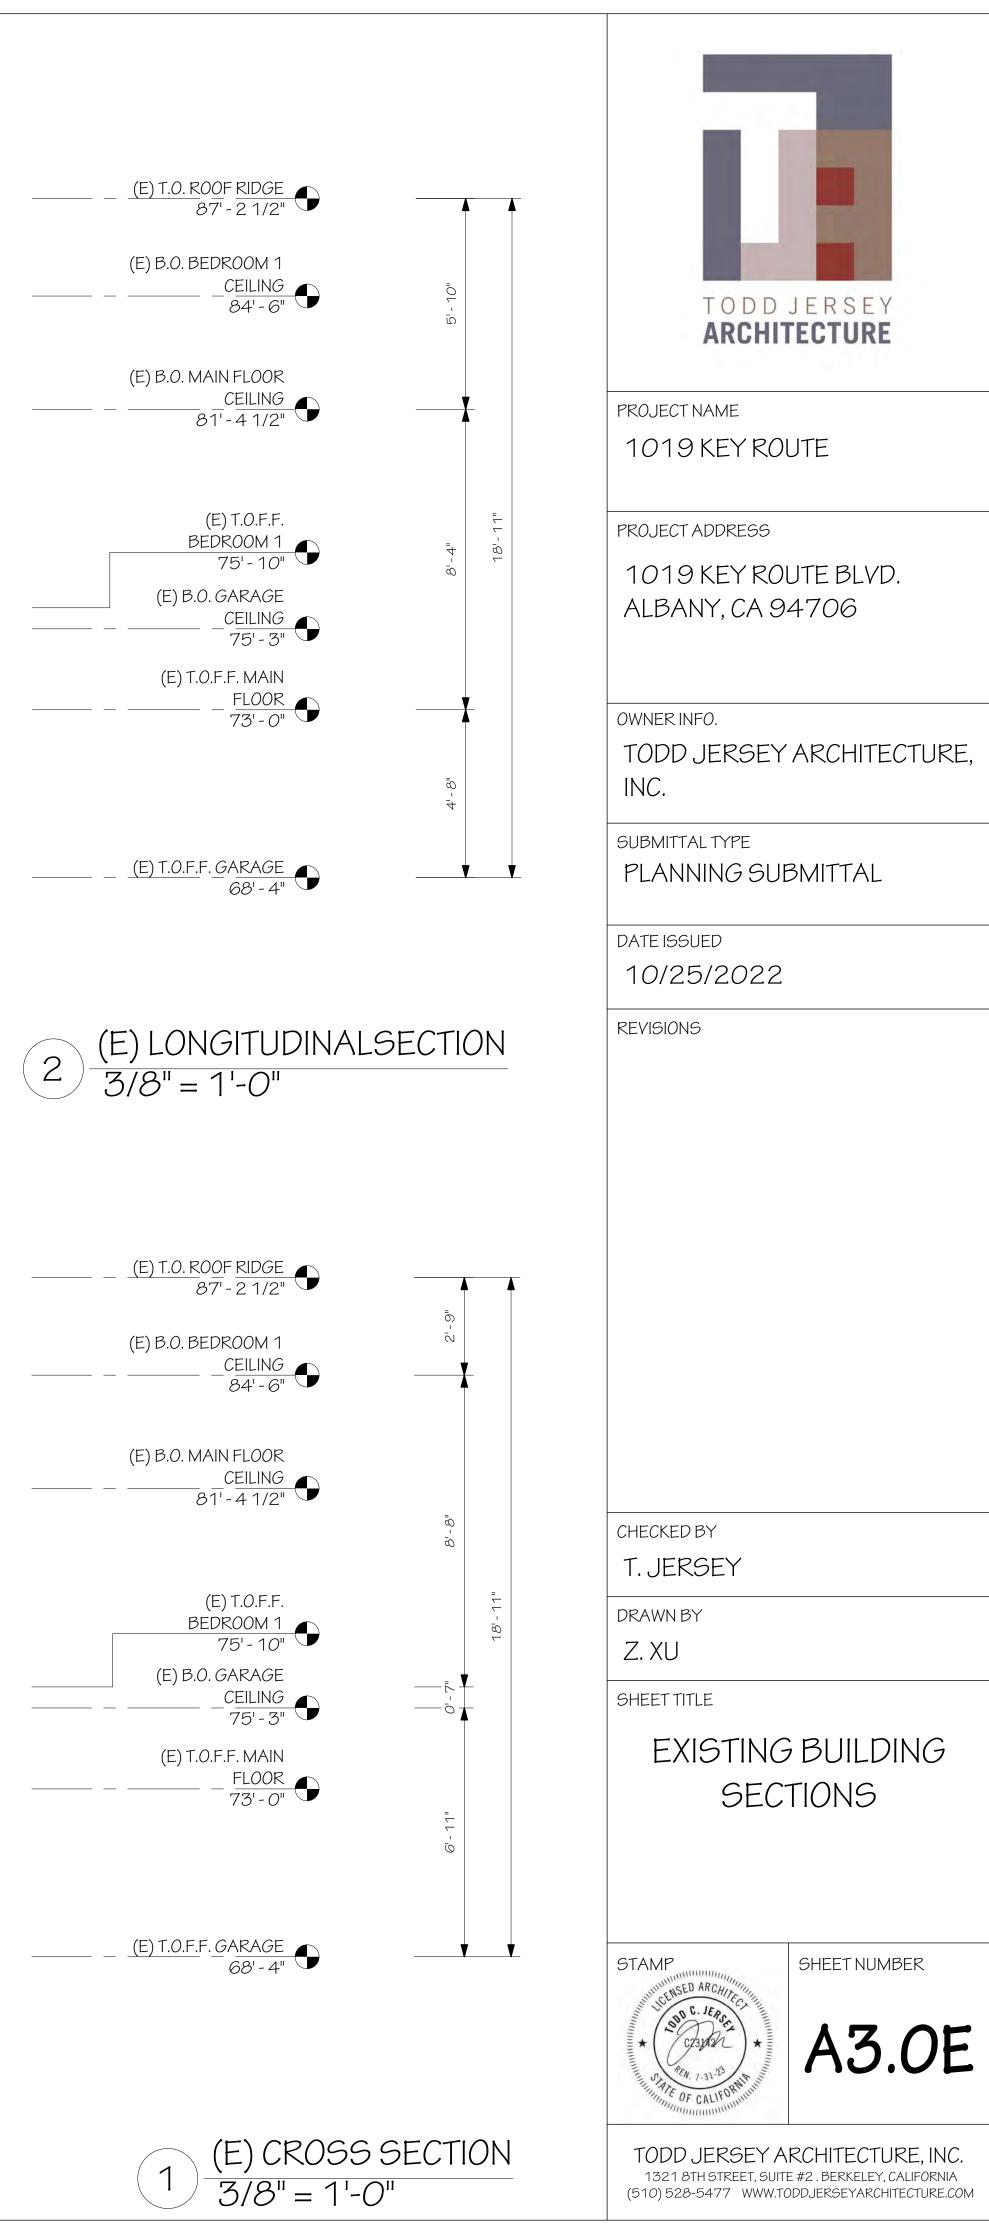

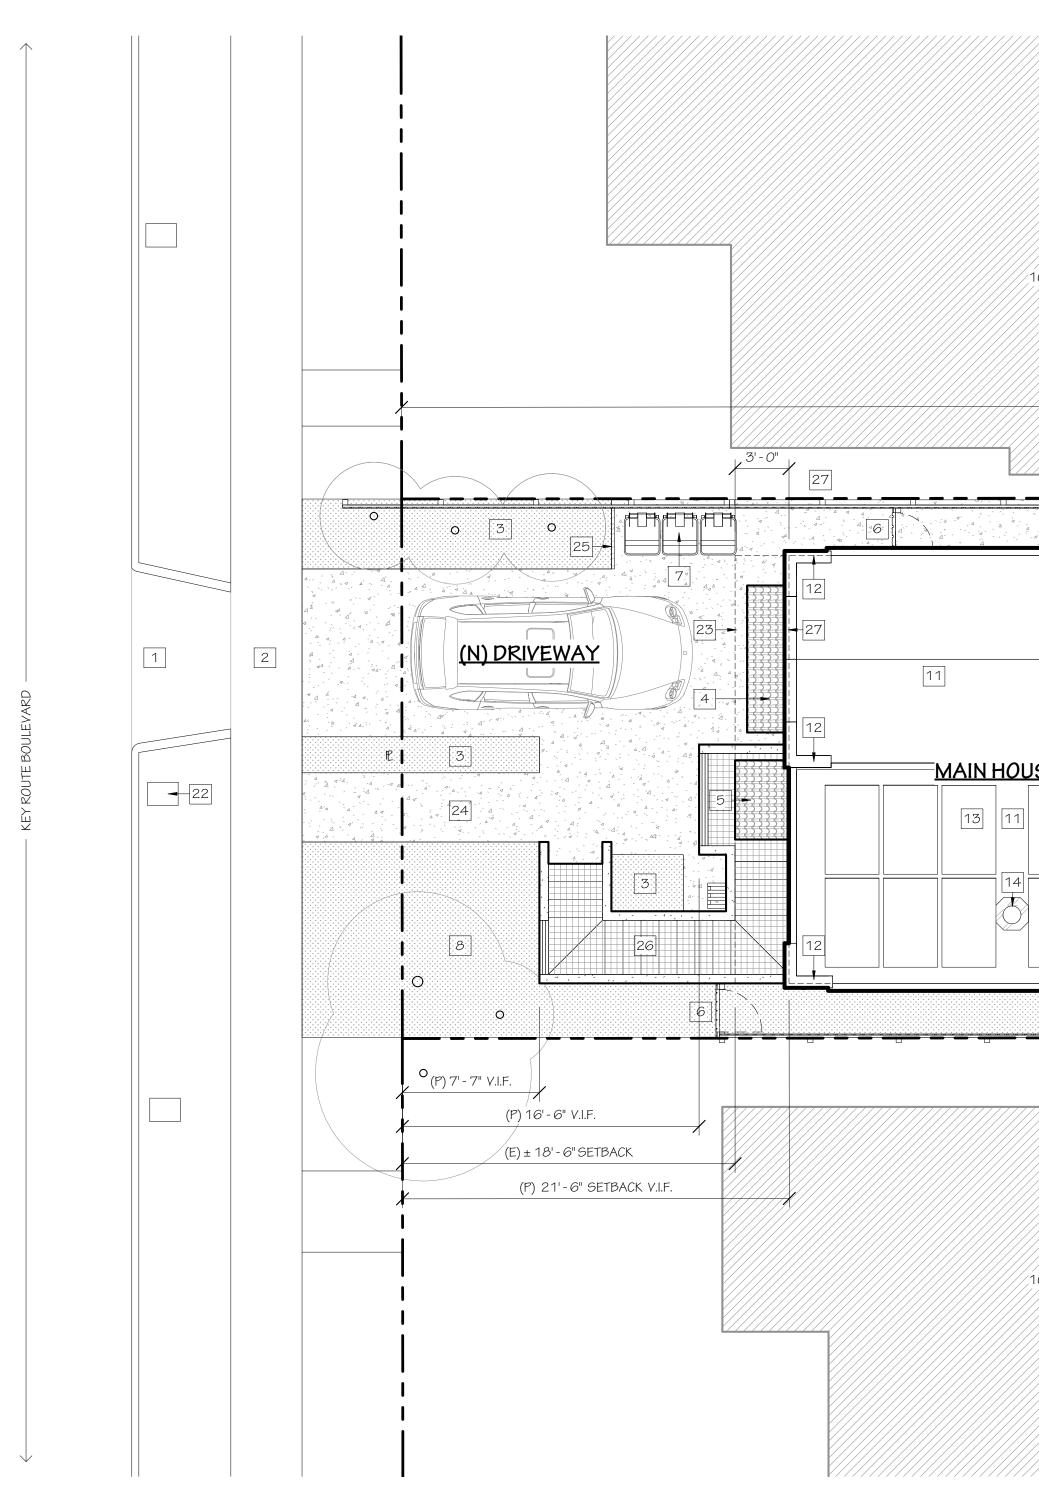

	KEY NOTES
	1 (E) CURB - CUT
	2 (E) SIDE WALK
	3 (N) PLANTER
	4 (N) BAY WINDOW ROOF, SPANISH TILE
	5 (N) LANDING CANOPY, SPANISH TILE
	6 (N) SIDE YARD GATE
	7 (N) TRASH BIN LOCATION
	8 (N) FRONT YARD, SOIL GROUND
	9 (N) FLASHING
	10 (E) SEWER CLEANOUT
	11 (E) TORCH-DOWN ROOF
	12 RECREATE AND ENHANCE (E) FEATURE
	13 (N) SOLAR PANEL, TYP.
	14 (N) SOLAR TUBE
	15 (N) SKYLIGHT
017 KEY ROUTE BLVD, ALBANY, CA ± 124'- 9" 12'- 6" (N) ADDITION 30 11 31 12'- 6" (N) ADDITION	SITE NOTES: (E) STRUCTURE TO BE SET BACK AN
30 11 11 14 9 17 15 15 15 16 17 6E (ELEVATED AND MOVED EAST 3') 17	
	N) PATIO
O21 KEY ROUTE BLVD, ALBANY, CA	(P) 63' - 2" BACKYARD SETBACK, V.I.F.

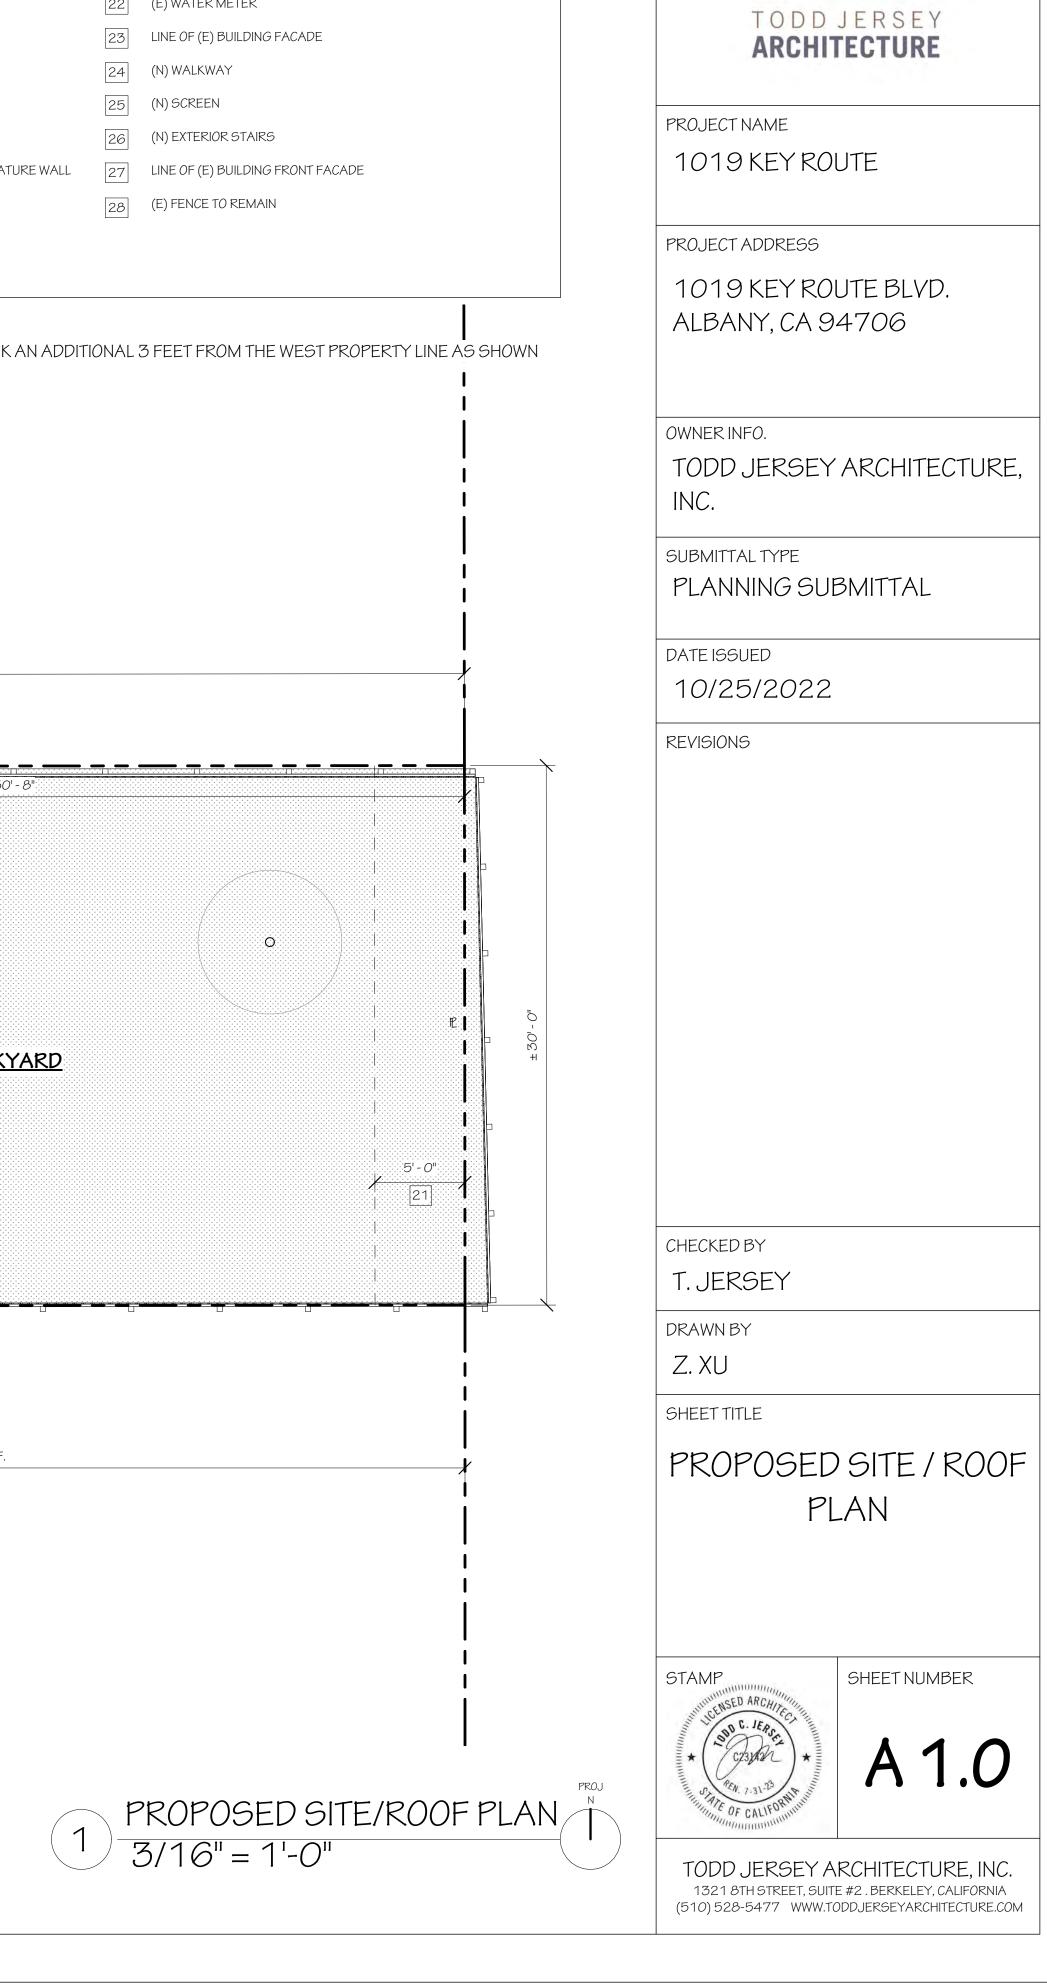

16 (N) GUTTER

19 (N) BBQ STOVE


18 (N) UPPER LEVEL BALCONY

(E) UTILITY EASEMENT

22 (E) WATER METER


[17] (N) STANDING SEAM METAL ROOF OF (N) ADDITION BELOW

20 REMOVE (4) OF (E) TREES AT THIS LOCATION

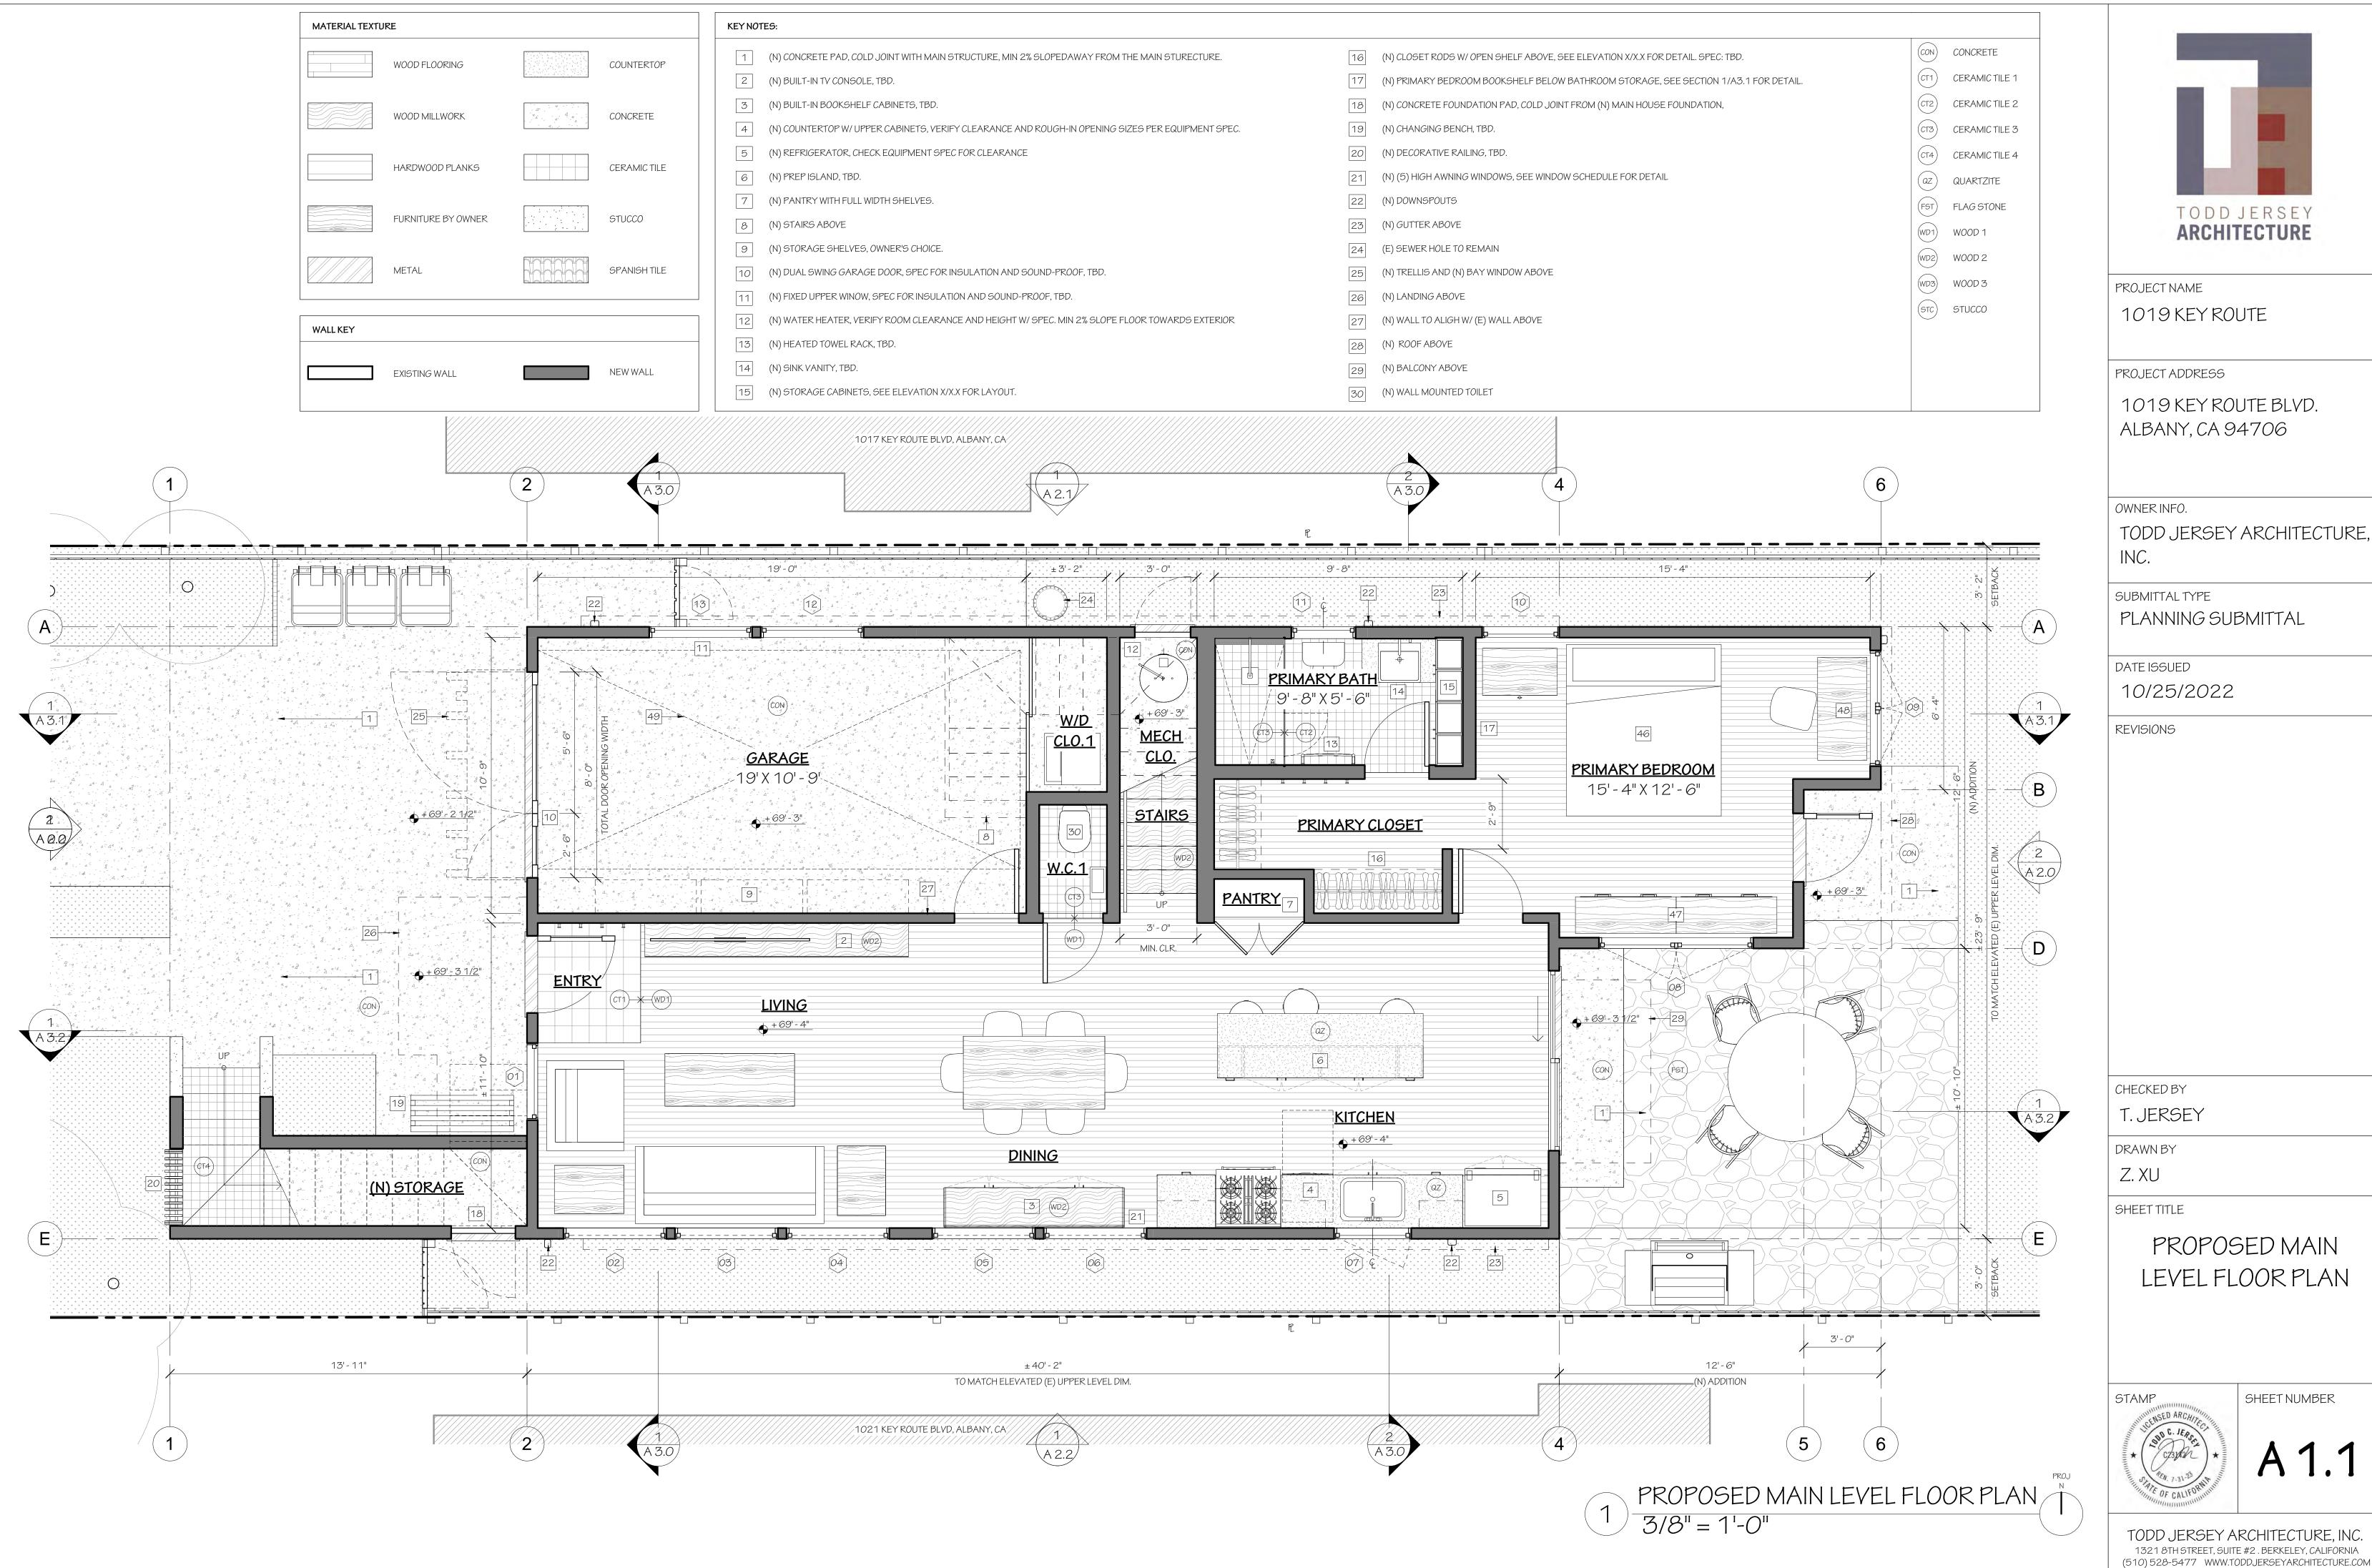

PROPOSED MAIN LEVEL FLOOR PLAN SHEET NUMBER


TODD JERSEY ARCHITECTURE,

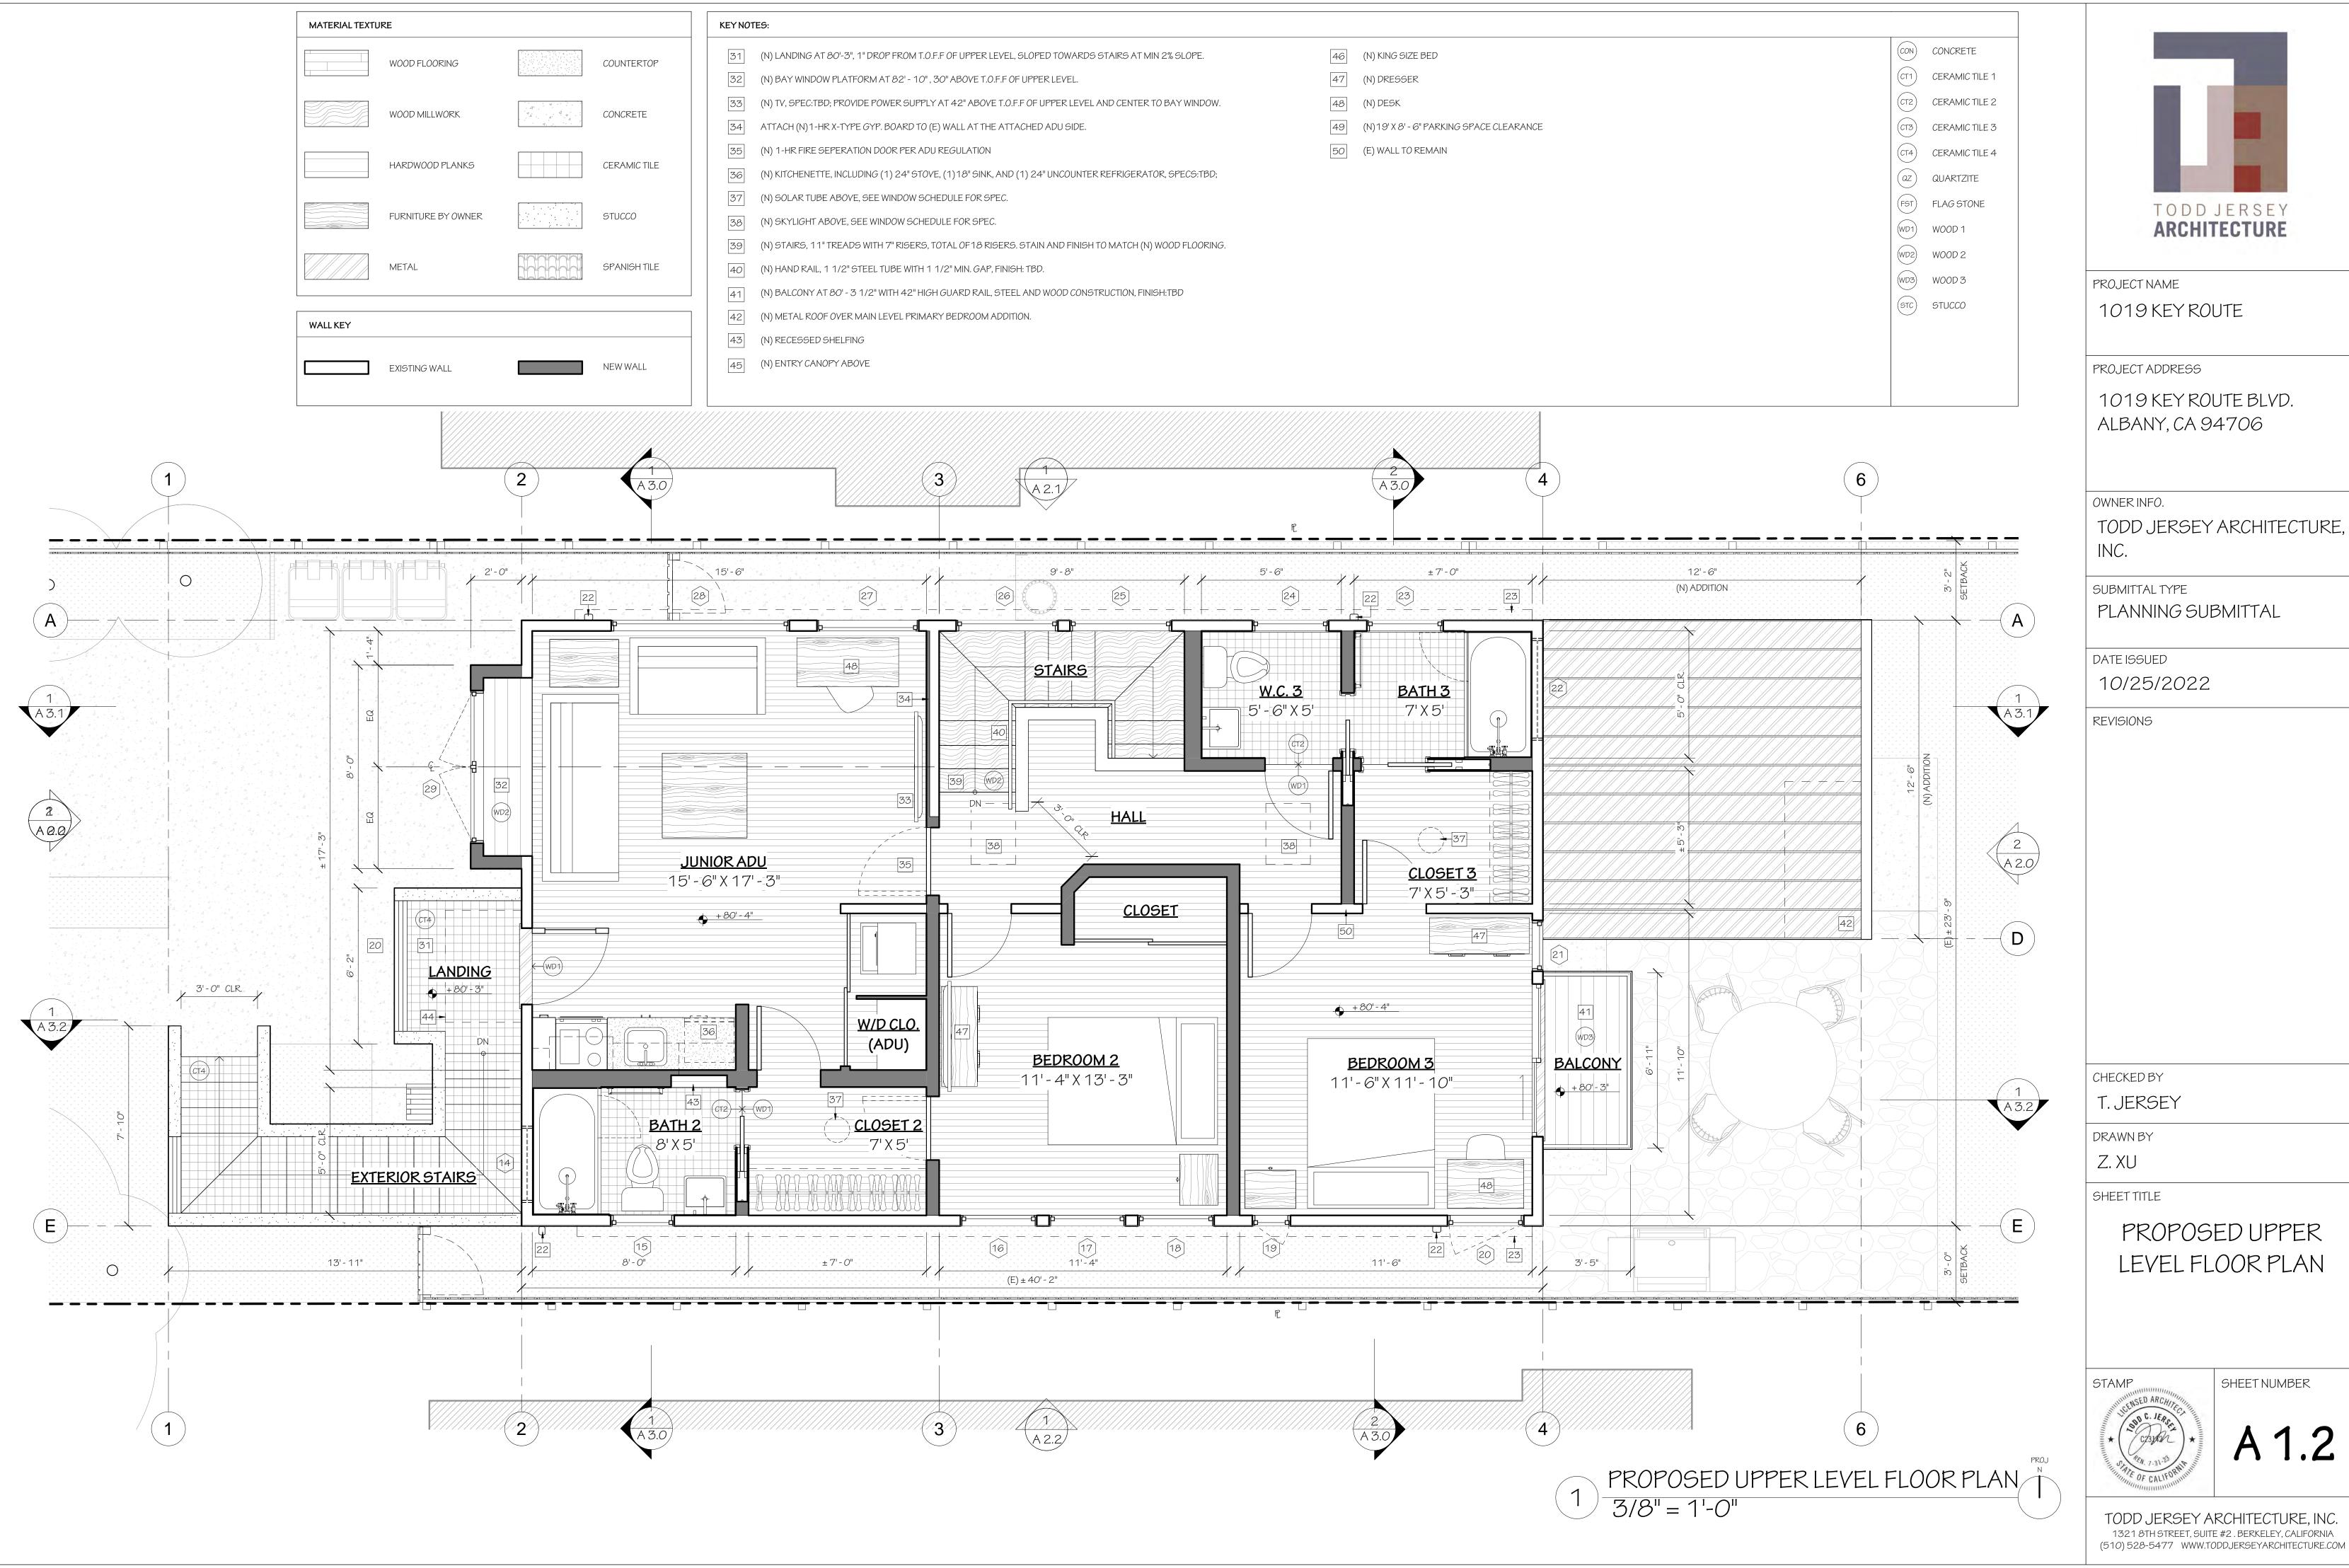


A 1.2

LEVEL FLOOR PLAN

TODD JERSEY ARCHITECTURE,

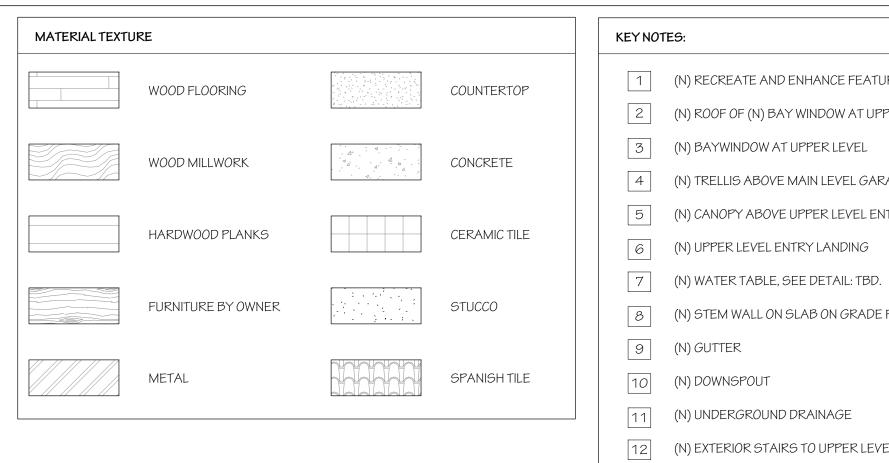

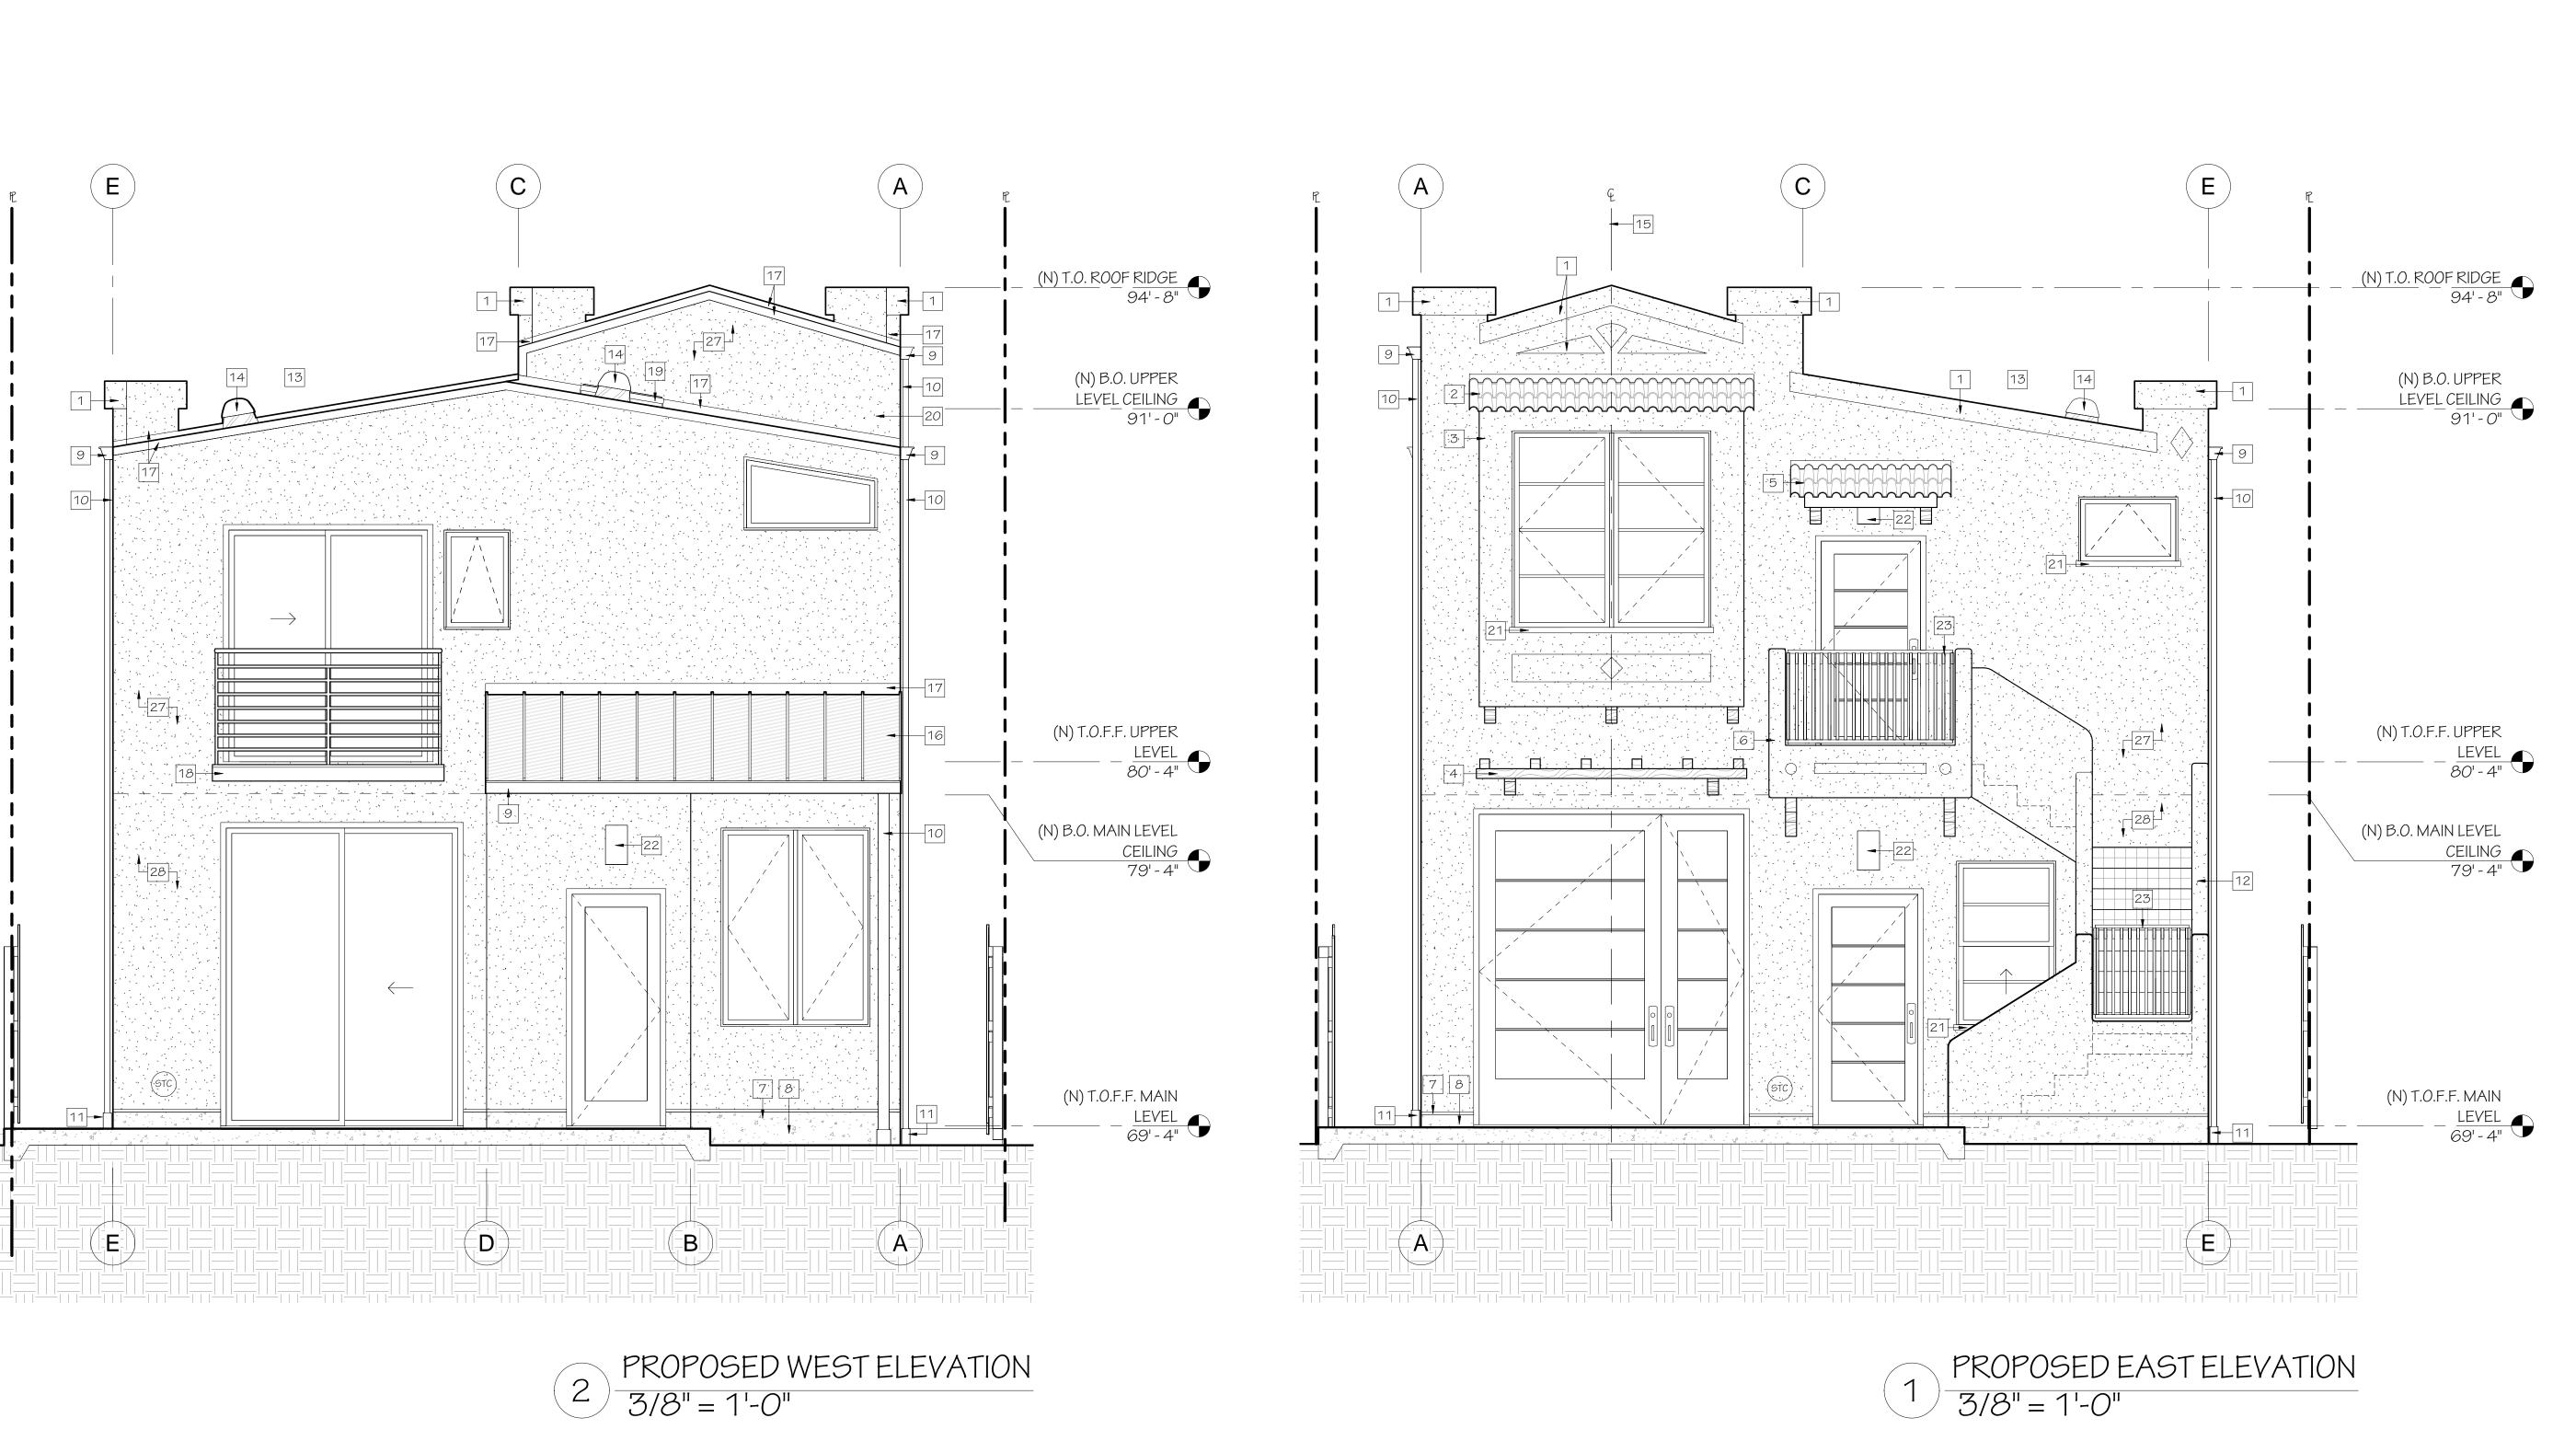


1 (N) RECREATE AND ENHANCE FEATURE WALL

- 2 (N) ROOF OF (N) BAY WINDOW AT UPPER LEVEL
- 3 (N) BAYWINDOW AT UPPER LEVEL
- (N) TRELLIS ABOVE MAIN LEVEL GARAGE ENTRY
- 5 (N) CANOPY ABOVE UPPER LEVEL ENTRY LANDING
- 6 (N) UPPER LEVEL ENTRY LANDING
- 8 (N) STEM WALL ON SLAB ON GRADE FOUNDATION
- 12 (N) EXTERIOR STAIRS TO UPPER LEVEL
- [13] (N) SOLAR PANEL NOT SHOWN FOR CLARITY, SEE ROOF PLAN
- 14 (N) SOLAR TUBE BEYOND
- [15] CENTER LINE OF (E) HIGHER ROOF, (N) BAY WINDOW, (N) TRELLIS AND (N) GARAGE DOOR

- [16] (N) STANDING SEAM METAL ROOF
- [17] (N) ROOF TO WALL FLASHING, SEE DETAIL: TBD.
- [18] (N) STEEL AND WOOD BALCONY WITH STEEL GUARDRAIL AT 42" A.F.F.
- 19 (N) SKYLIGHT BEYOND
- 20 (E) HIGHER WALL BEYOND
- 21 (N) WOOD SILL
- 22 (N) SPANISH STYLE SCONCE
- 23 (N) DECORATIVE STEEL RAILING
- 24 (E) TORCH DOWN ROOF
- (N) CONCRETE WALK AT ELEVATION + 69' 0"
- 26 (N) BACKYARD FLAGSTONE PLATFORM AT ELEVATION + 69' - 3"
- 27 (E) EXTERIOR WALL TO REMAIN AS (N) UPPER LEVEL, REFINISH W/ (N) ELASTOMERIC STUCCO
- 28 (N) MAIN LEVEL ELASTOMERIC STUCCO EXTERIOR WALL
- 29 BOTTOM OF (N) EXTERIOR STAIRS BEYOND
- 30 (N) CHANGING BENCH BEYOND

	CON	CONCRETE
	(CT1)	CERAMIC TILE 1
	CT2	CERAMIC TILE 2
	CT3	CERAMIC TILE 3
	CT4	CERAMIC TILE 4
	QZ	QUARTZITE
	FST	FLAG STONE
	WD1	WOOD 1
	WD2	WOOD 2
	WD3	WOOD 3
CO OVER EXISTING	STC	STUCCO

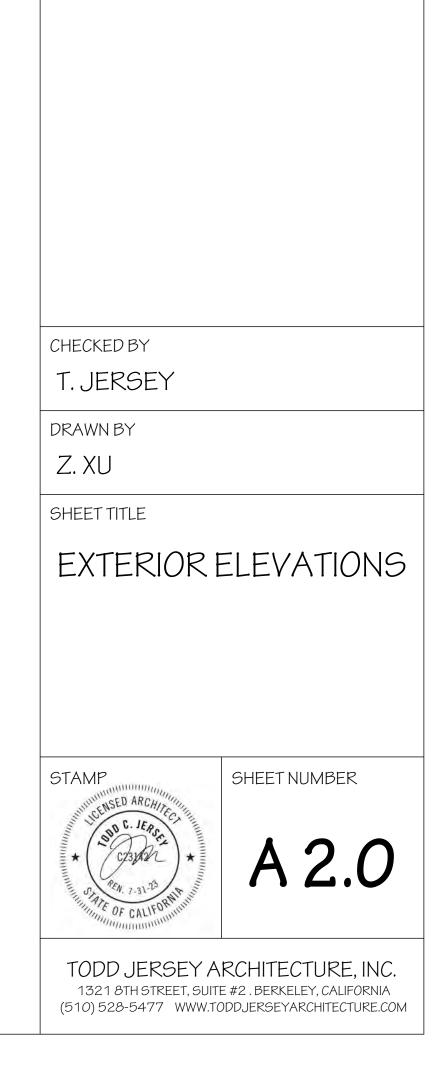

REVISIONS

DATE ISSUED 10/25/2022


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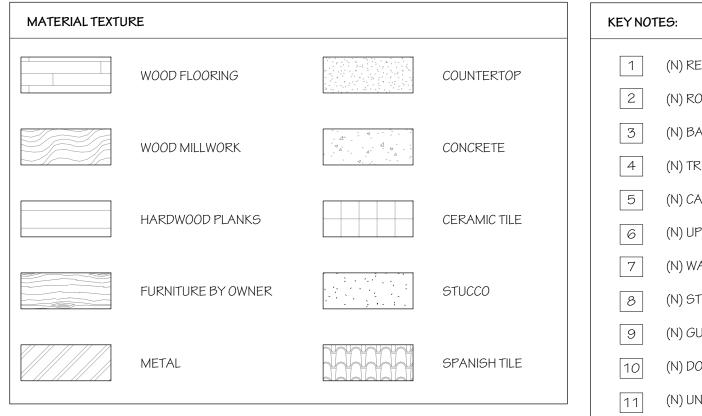
OWNER INFO. TODD JERSEY ARCHITECTURE, INC.


1019 KEY ROUTE BLVD. ALBANY, CA 94706


PROJECTNAME 1019 KEY ROUTE


PROJECT ADDRESS



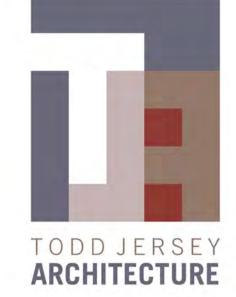

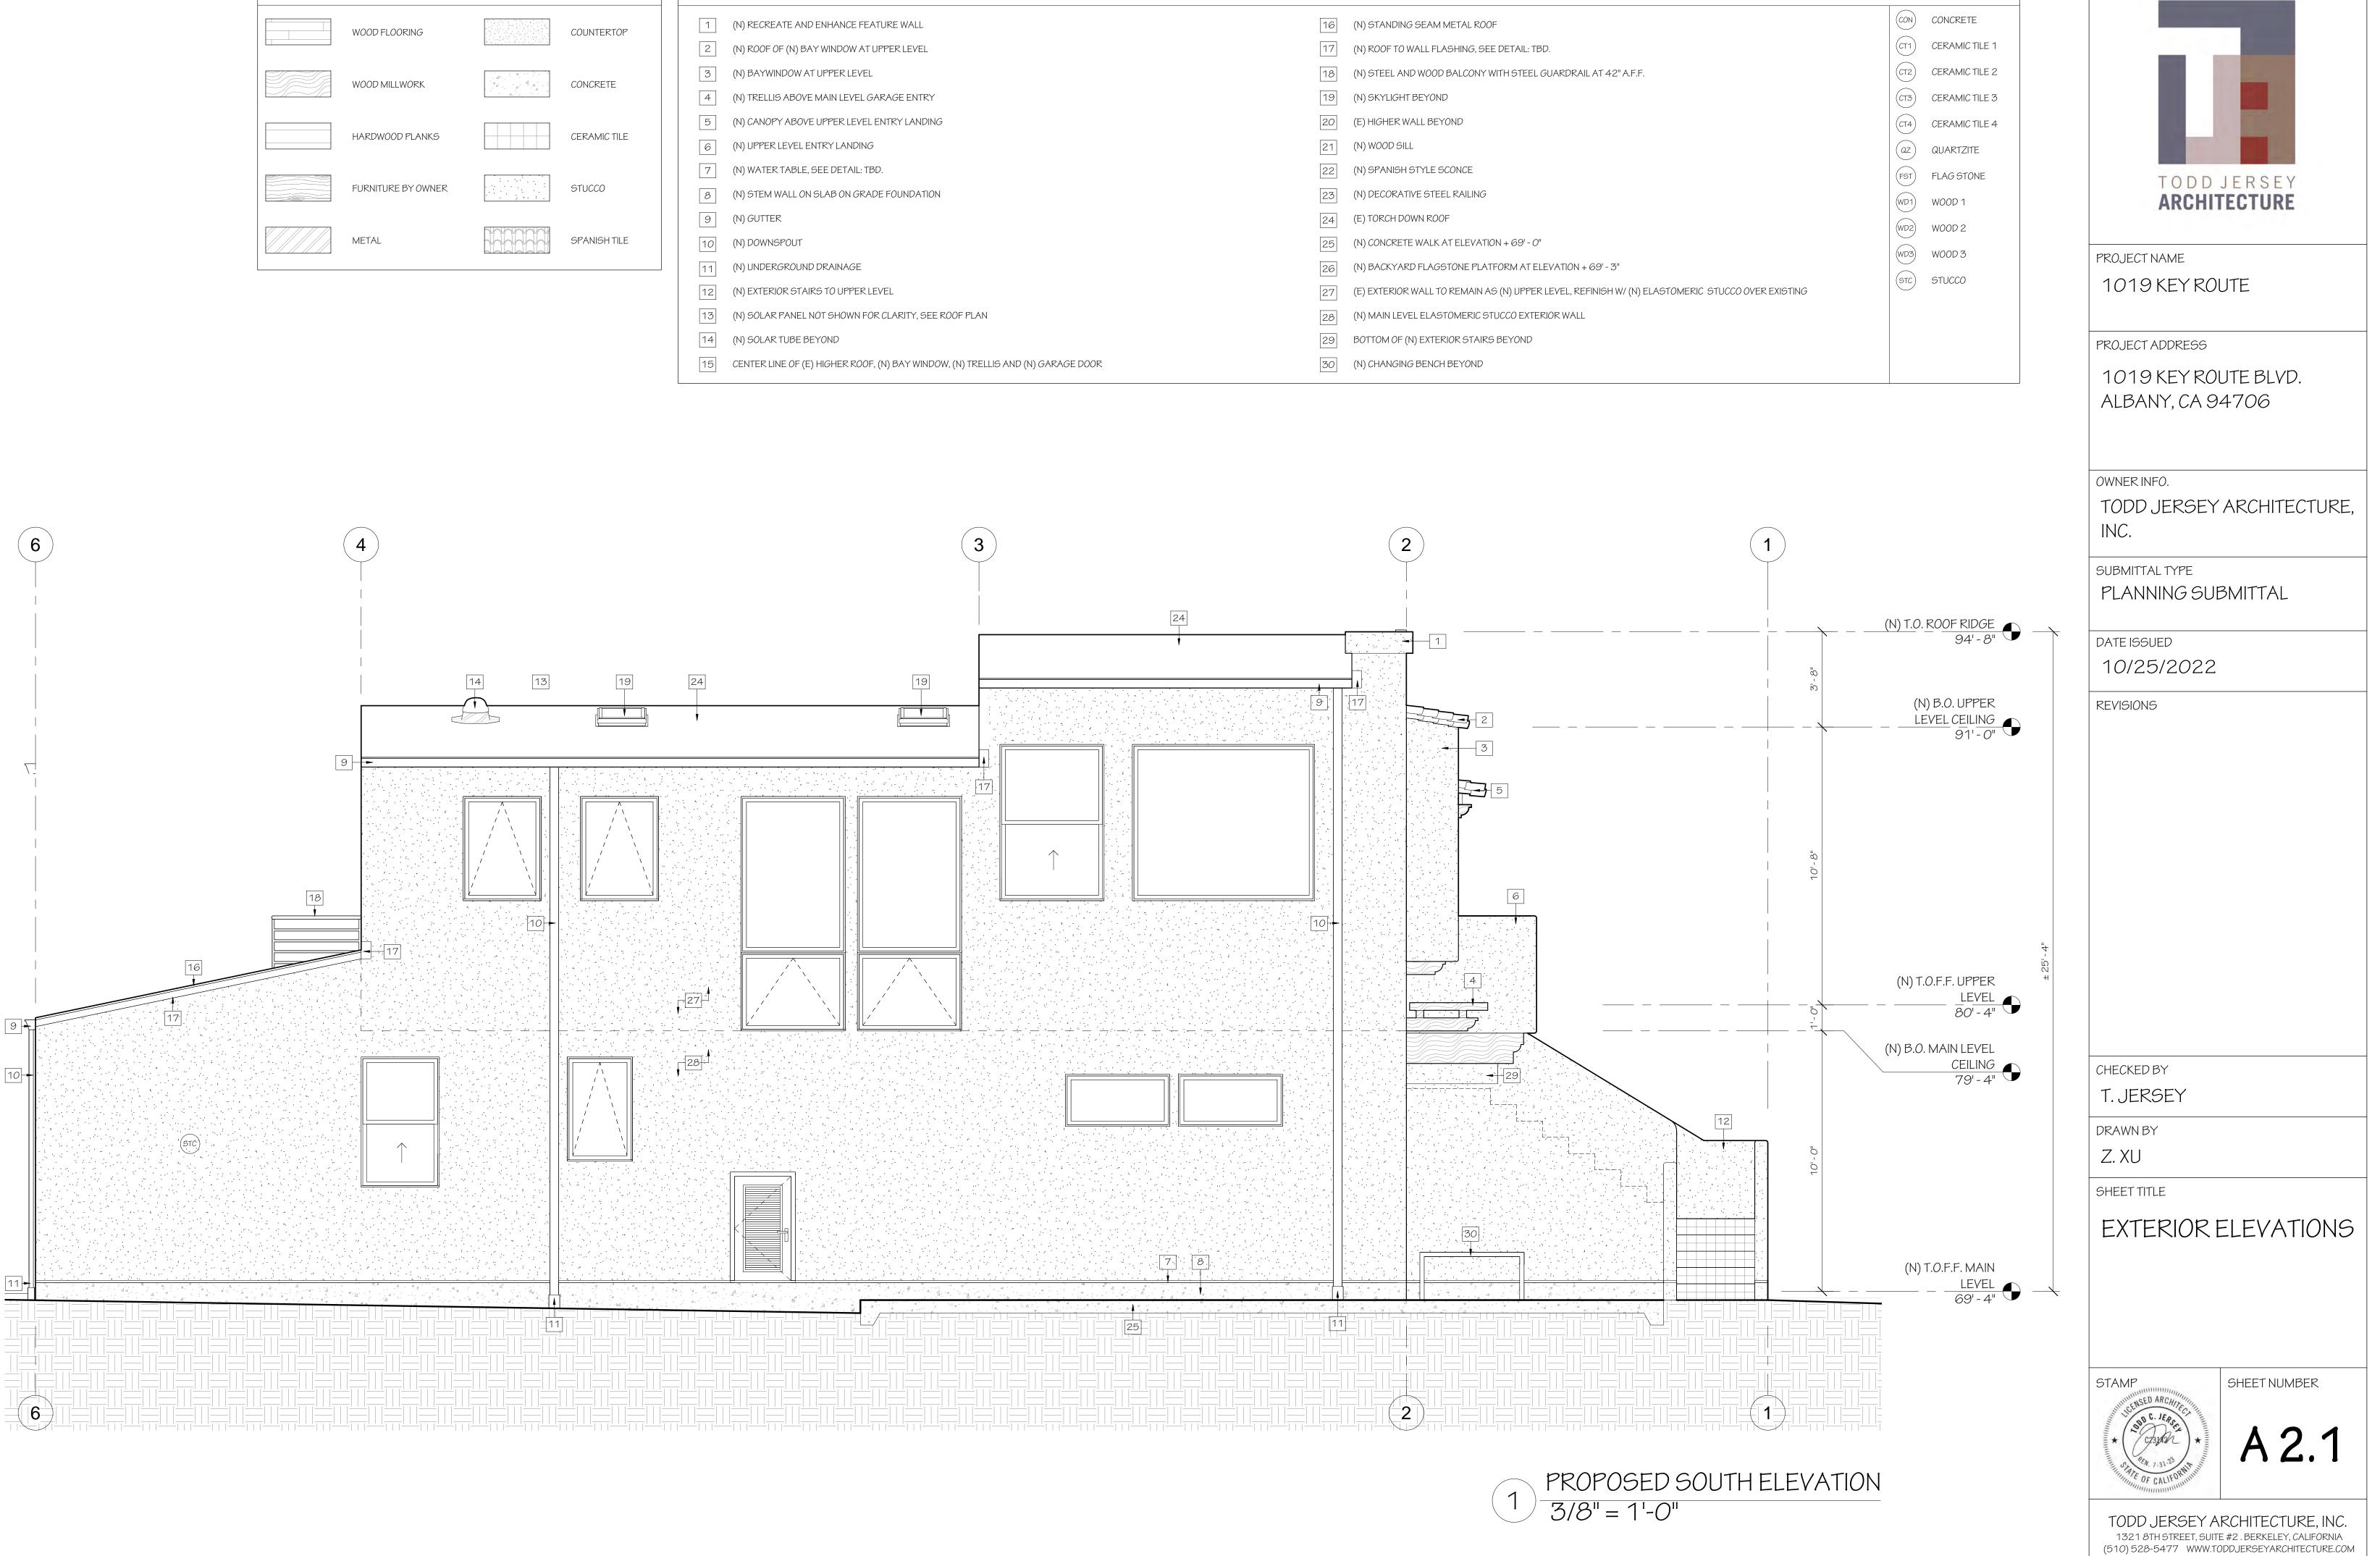

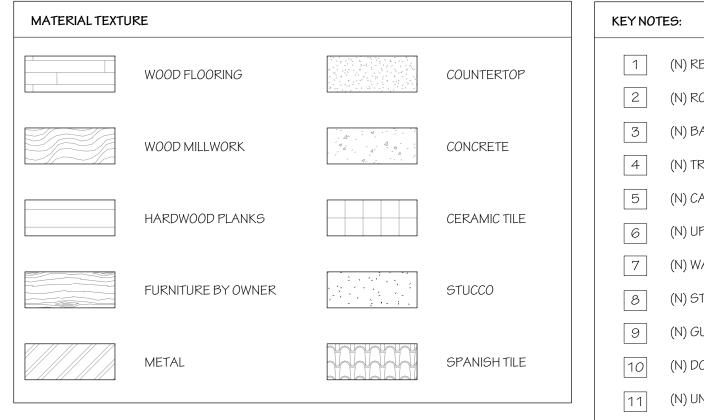

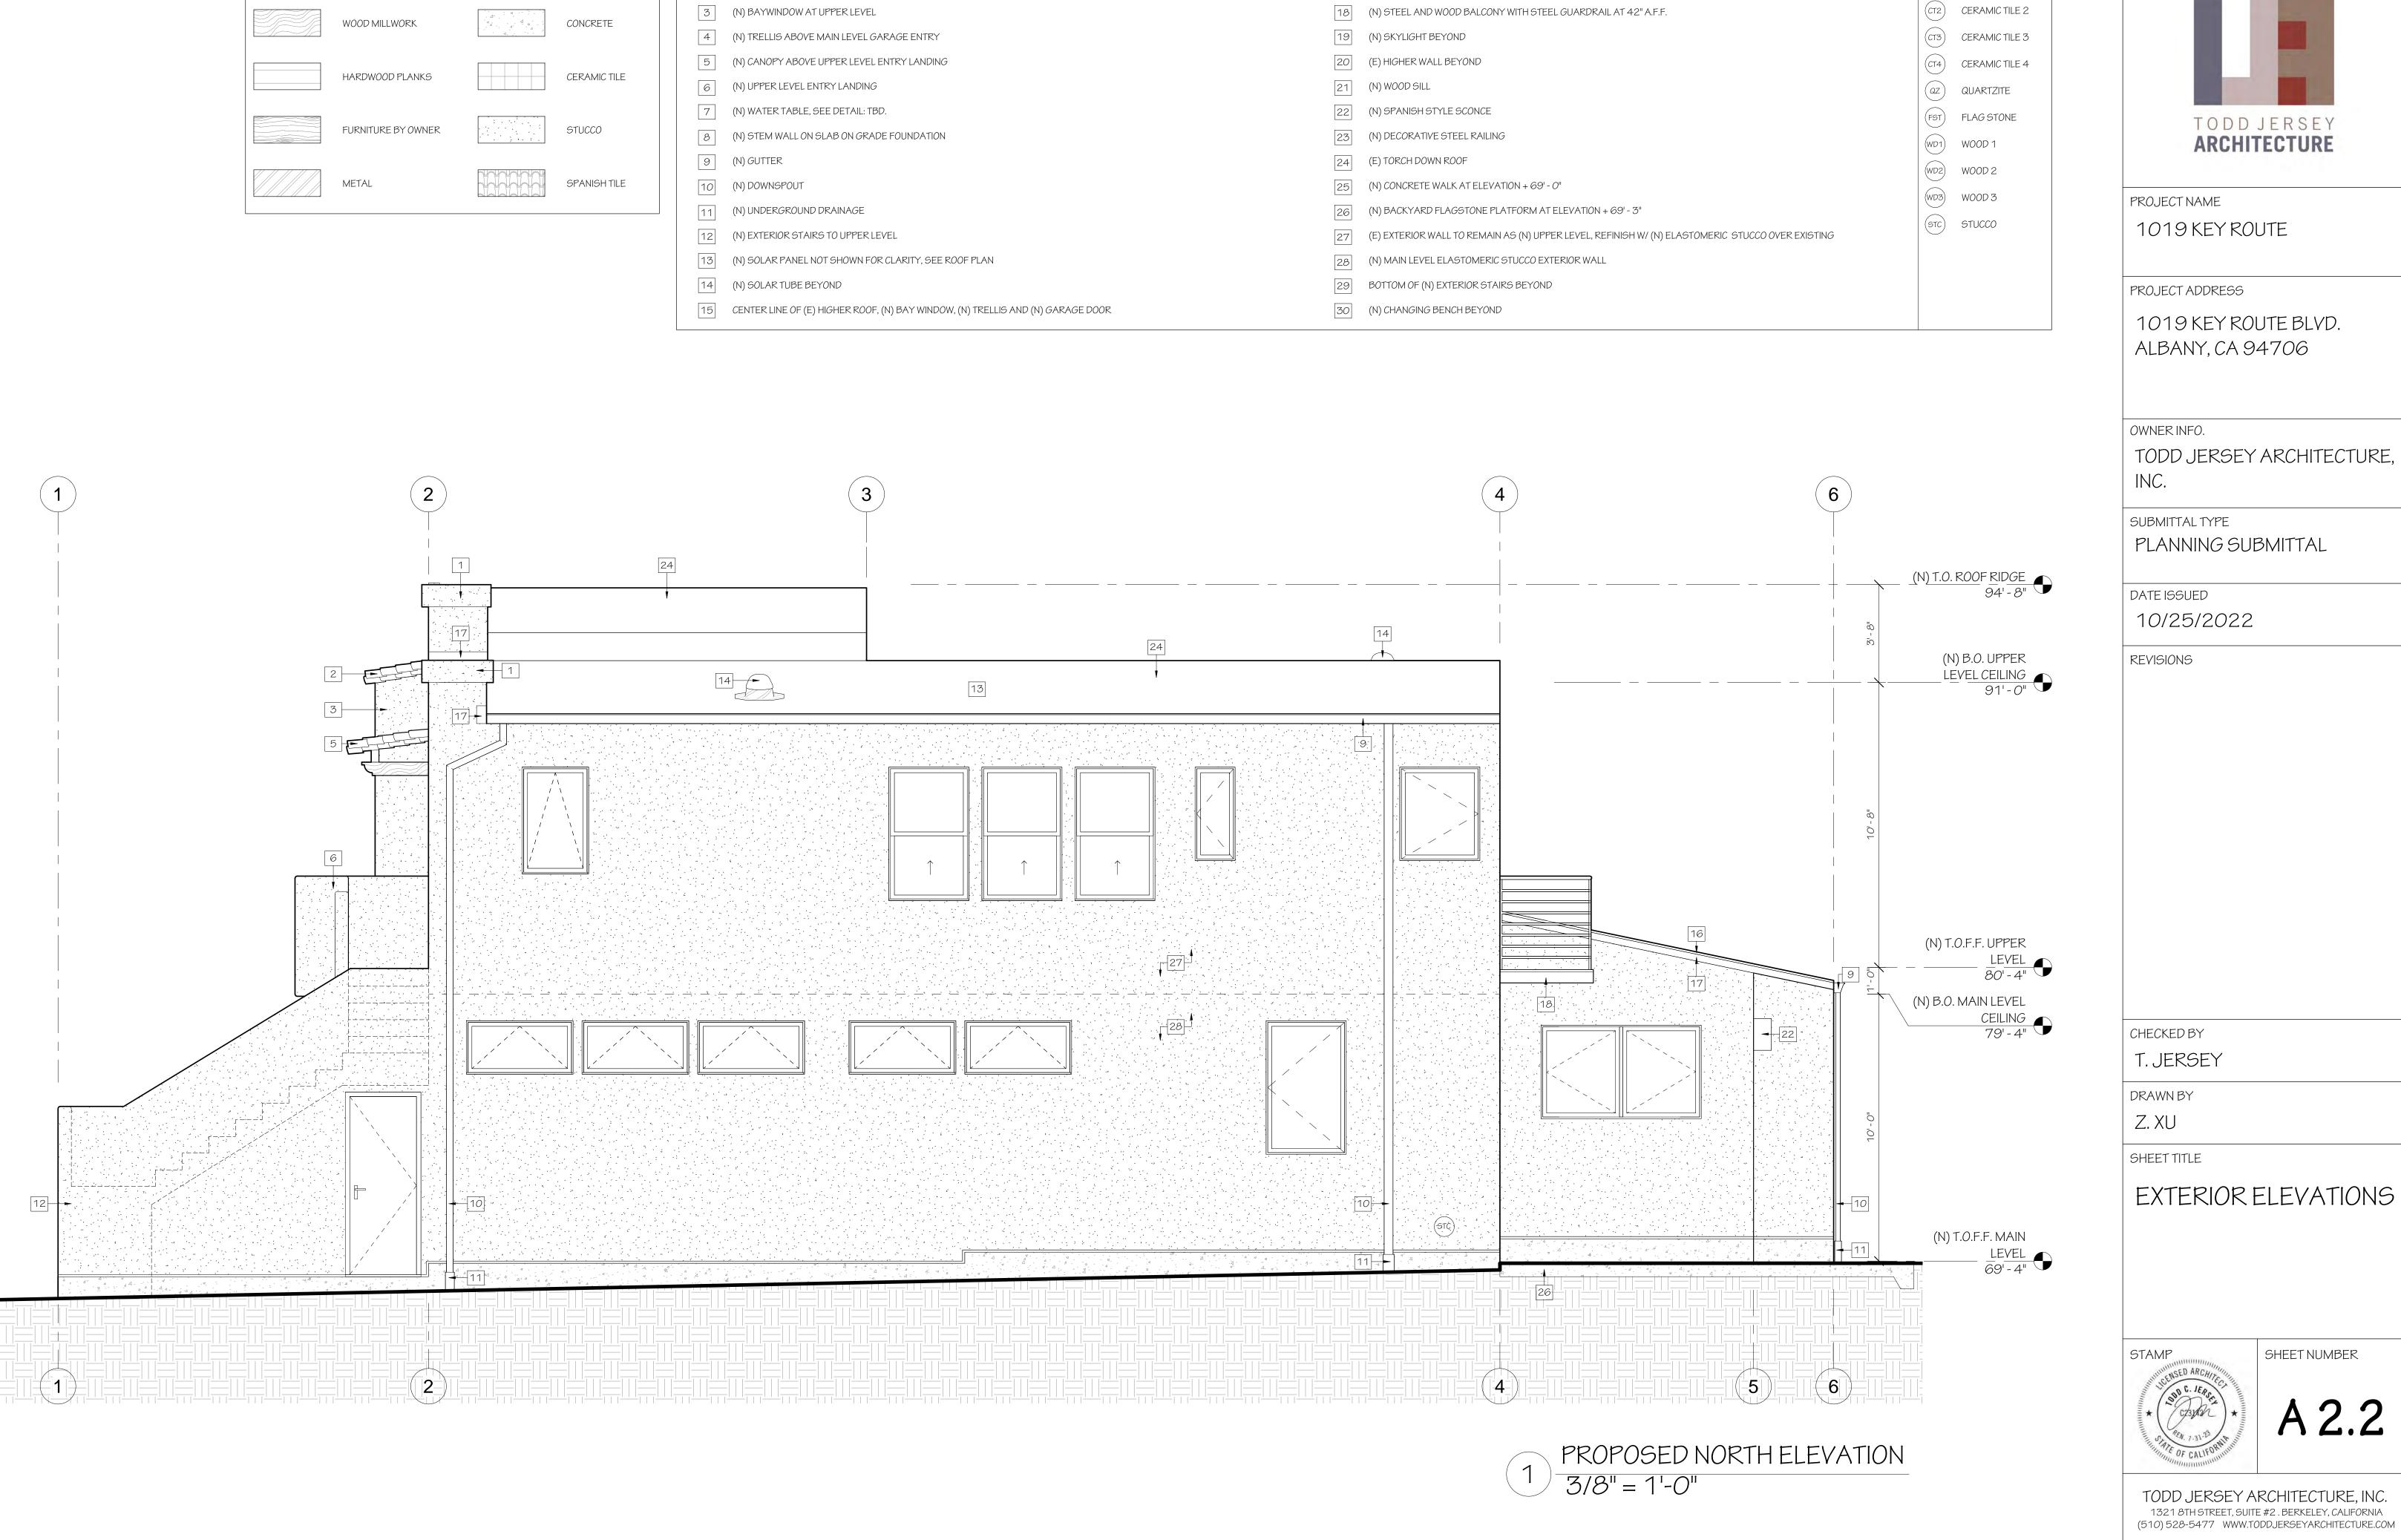


- 1 (N) RECREATE AND ENHANCE FEATURE WALL
- 2 (N) ROOF OF (N) BAY WINDOW AT UPPER LEVEL


- [16] (N) STANDING SEAM METAL ROOF
- [17] (N) ROOF TO WALL FLASHING, SEE DETAIL: TBD.
- [18] (N) STEEL AND WOOD BALCONY WITH STEEL GUARDRAIL AT 42" A.F.F.

CON CONCRETE

CT1 CERAMIC TILE 1

MATERIAL TEXTL	KEY NOTES		
	WOOD FLOORING	COUNTERTOP	1(N) UPPER CABINE2(N) PREP ISLAND
	WOOD MILLWORK	CONCRETE	3 (N) STORAGE CAB 4 (N) SHOWER GLAS
	HARDWOOD PLANKS	CERAMIC TILE	5 (N) SHELFING 6 (N) OPEN TO SOLA
	FURNITURE BY OWNER	STUCCO	7 (N) HEATED TOWE8 (N) BOOKSHELF. S
	METAL	SPANISH TILE	9 (N) SLOPED CEILIN 10 (N) FULL HEIGHT W
WALL KEY			11(N) BAY WINDOW F12(N) MICROWAVE H
	EXISTING WALL	NEW WALL	13(N) SHELFING14(N) UNDERCOUNTE15(N) SINK CABINET

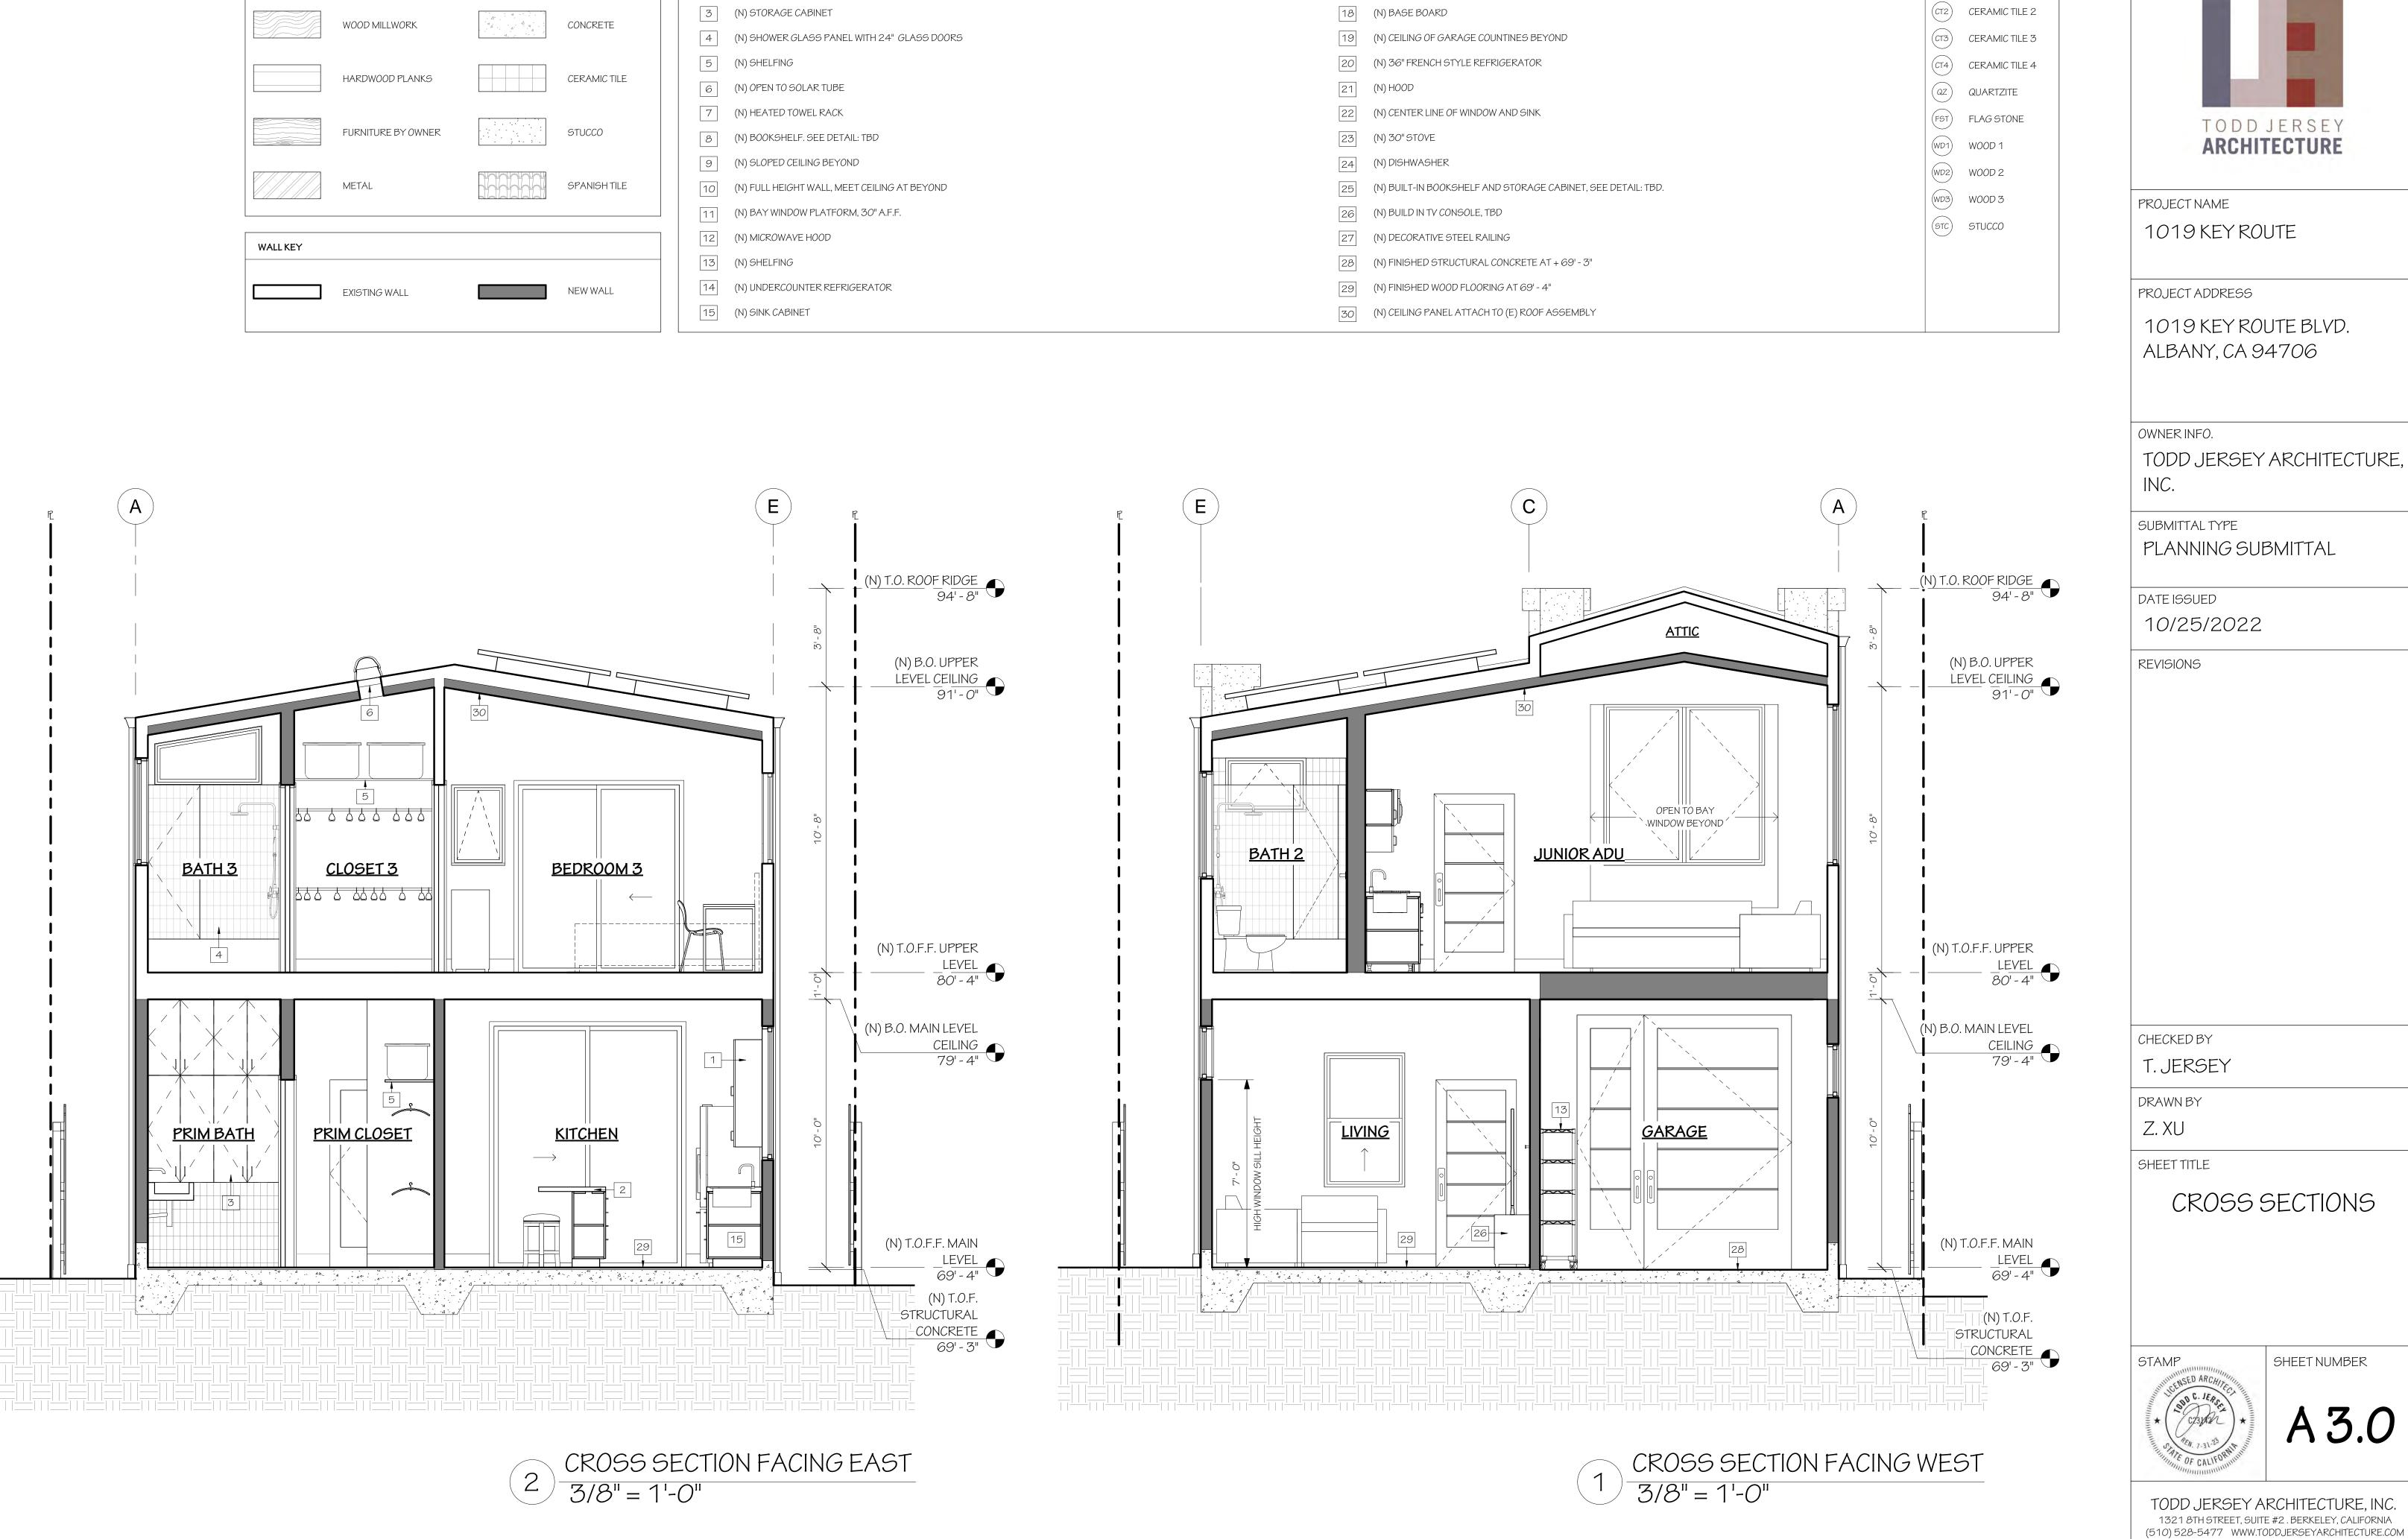

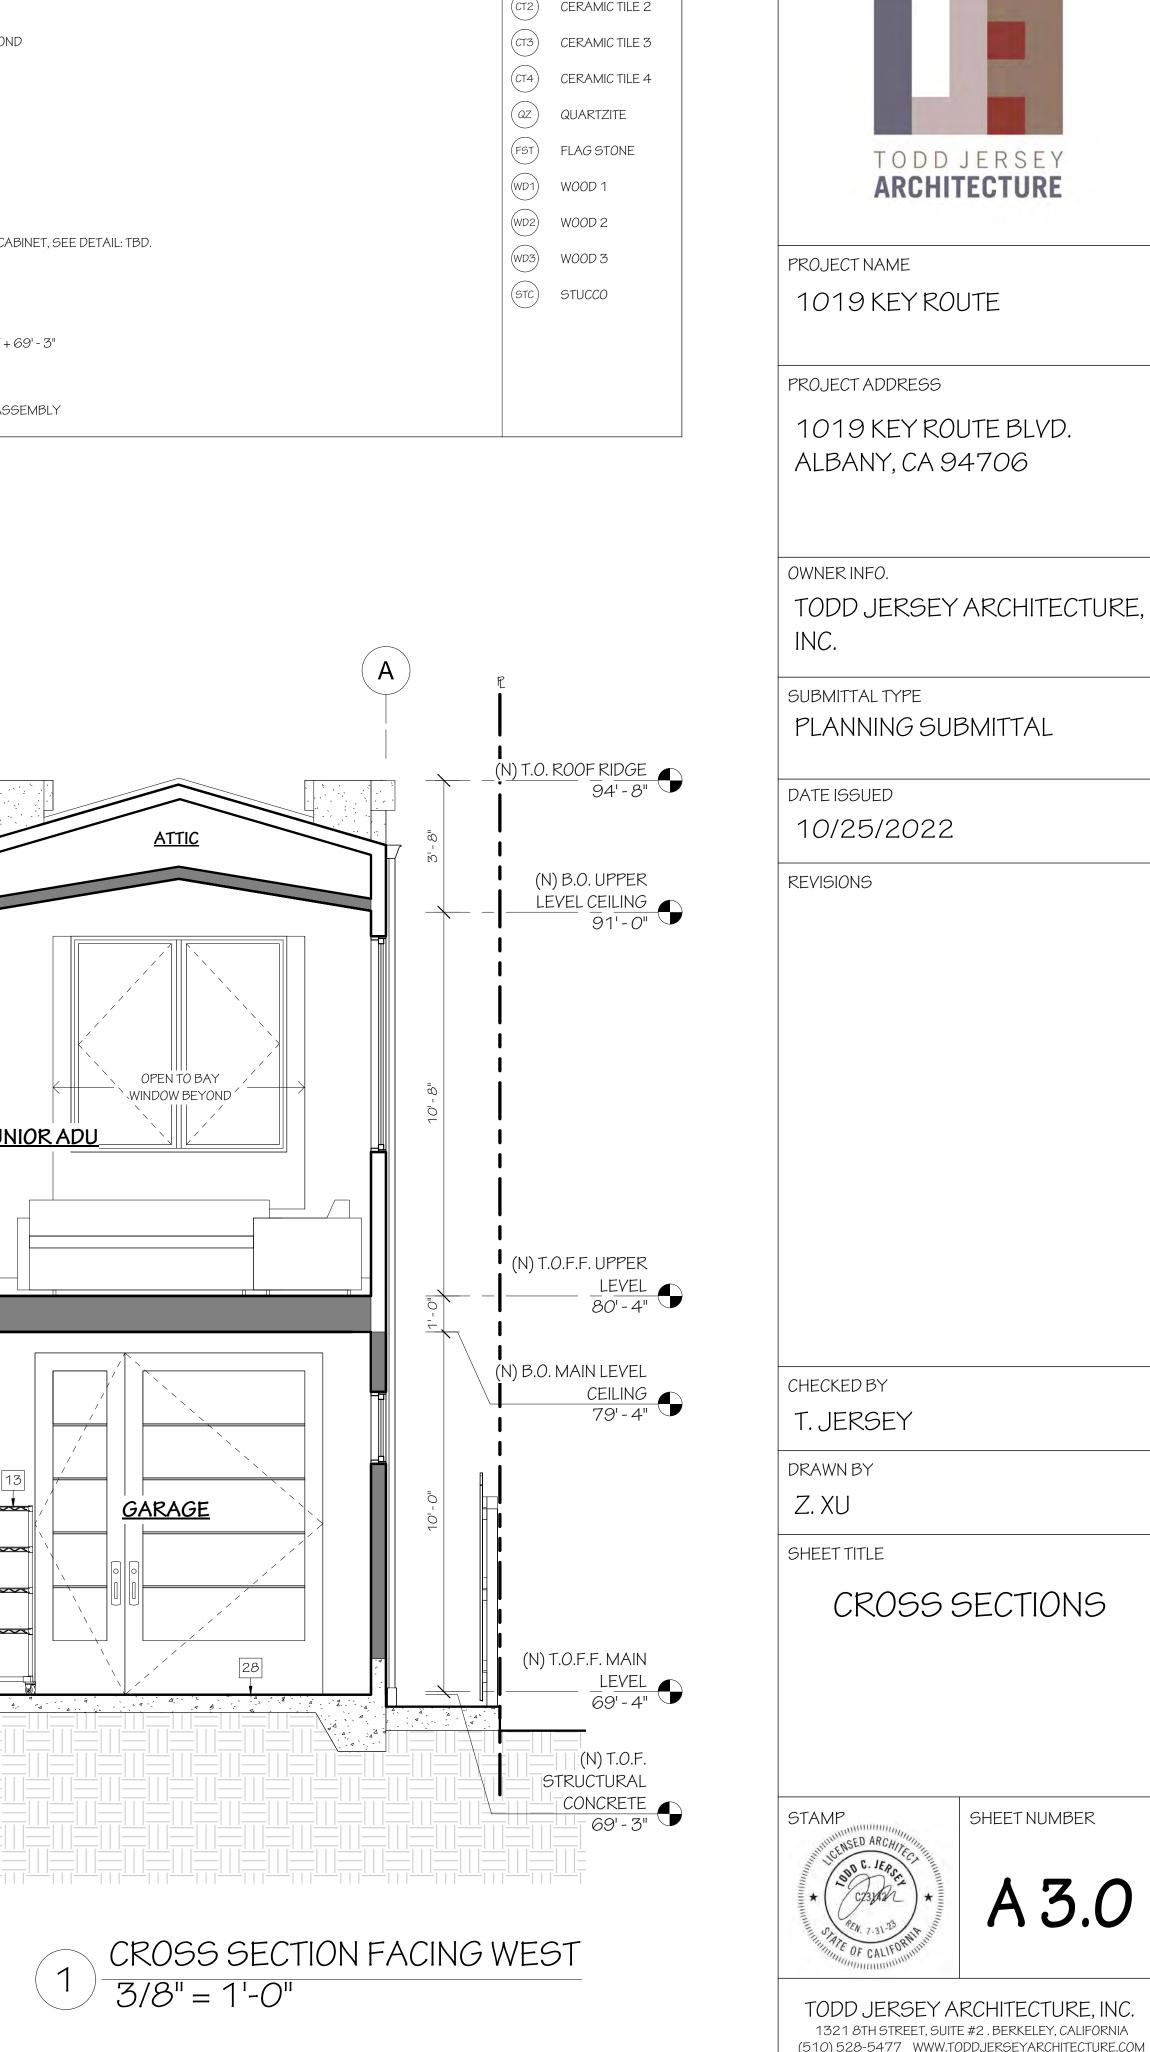


CON CONCRETE

CERAMIC TILE 1


CT1


- 16 (N) 24" STOVE
- [17] (N) DRAWER BASE, SEE PLAN FOR DIMENSION, TBD.

MATERIAL TEXTL	JRE		KEY NO	TES
	WOOD FLOORING	COUNTERTOP	1	(N) L (N) F
	WOOD MILLWORK	CONCRETE	3	(N) 8 (N) 8
	HARDWOOD PLANKS	CERAMIC TILE	5	(N) 8 (N) 0
	FURNITURE BY OWNER	STUCCO	7	(N) H (N) E
	METAL	SPANISH TILE	9	(N) 9 (N) F
			11	(N) E
WALL KEY			12	(N) N
			13	(N) 8
	EXISTING WALL	NEW WALL	14	(N) l
			15	(N) 6

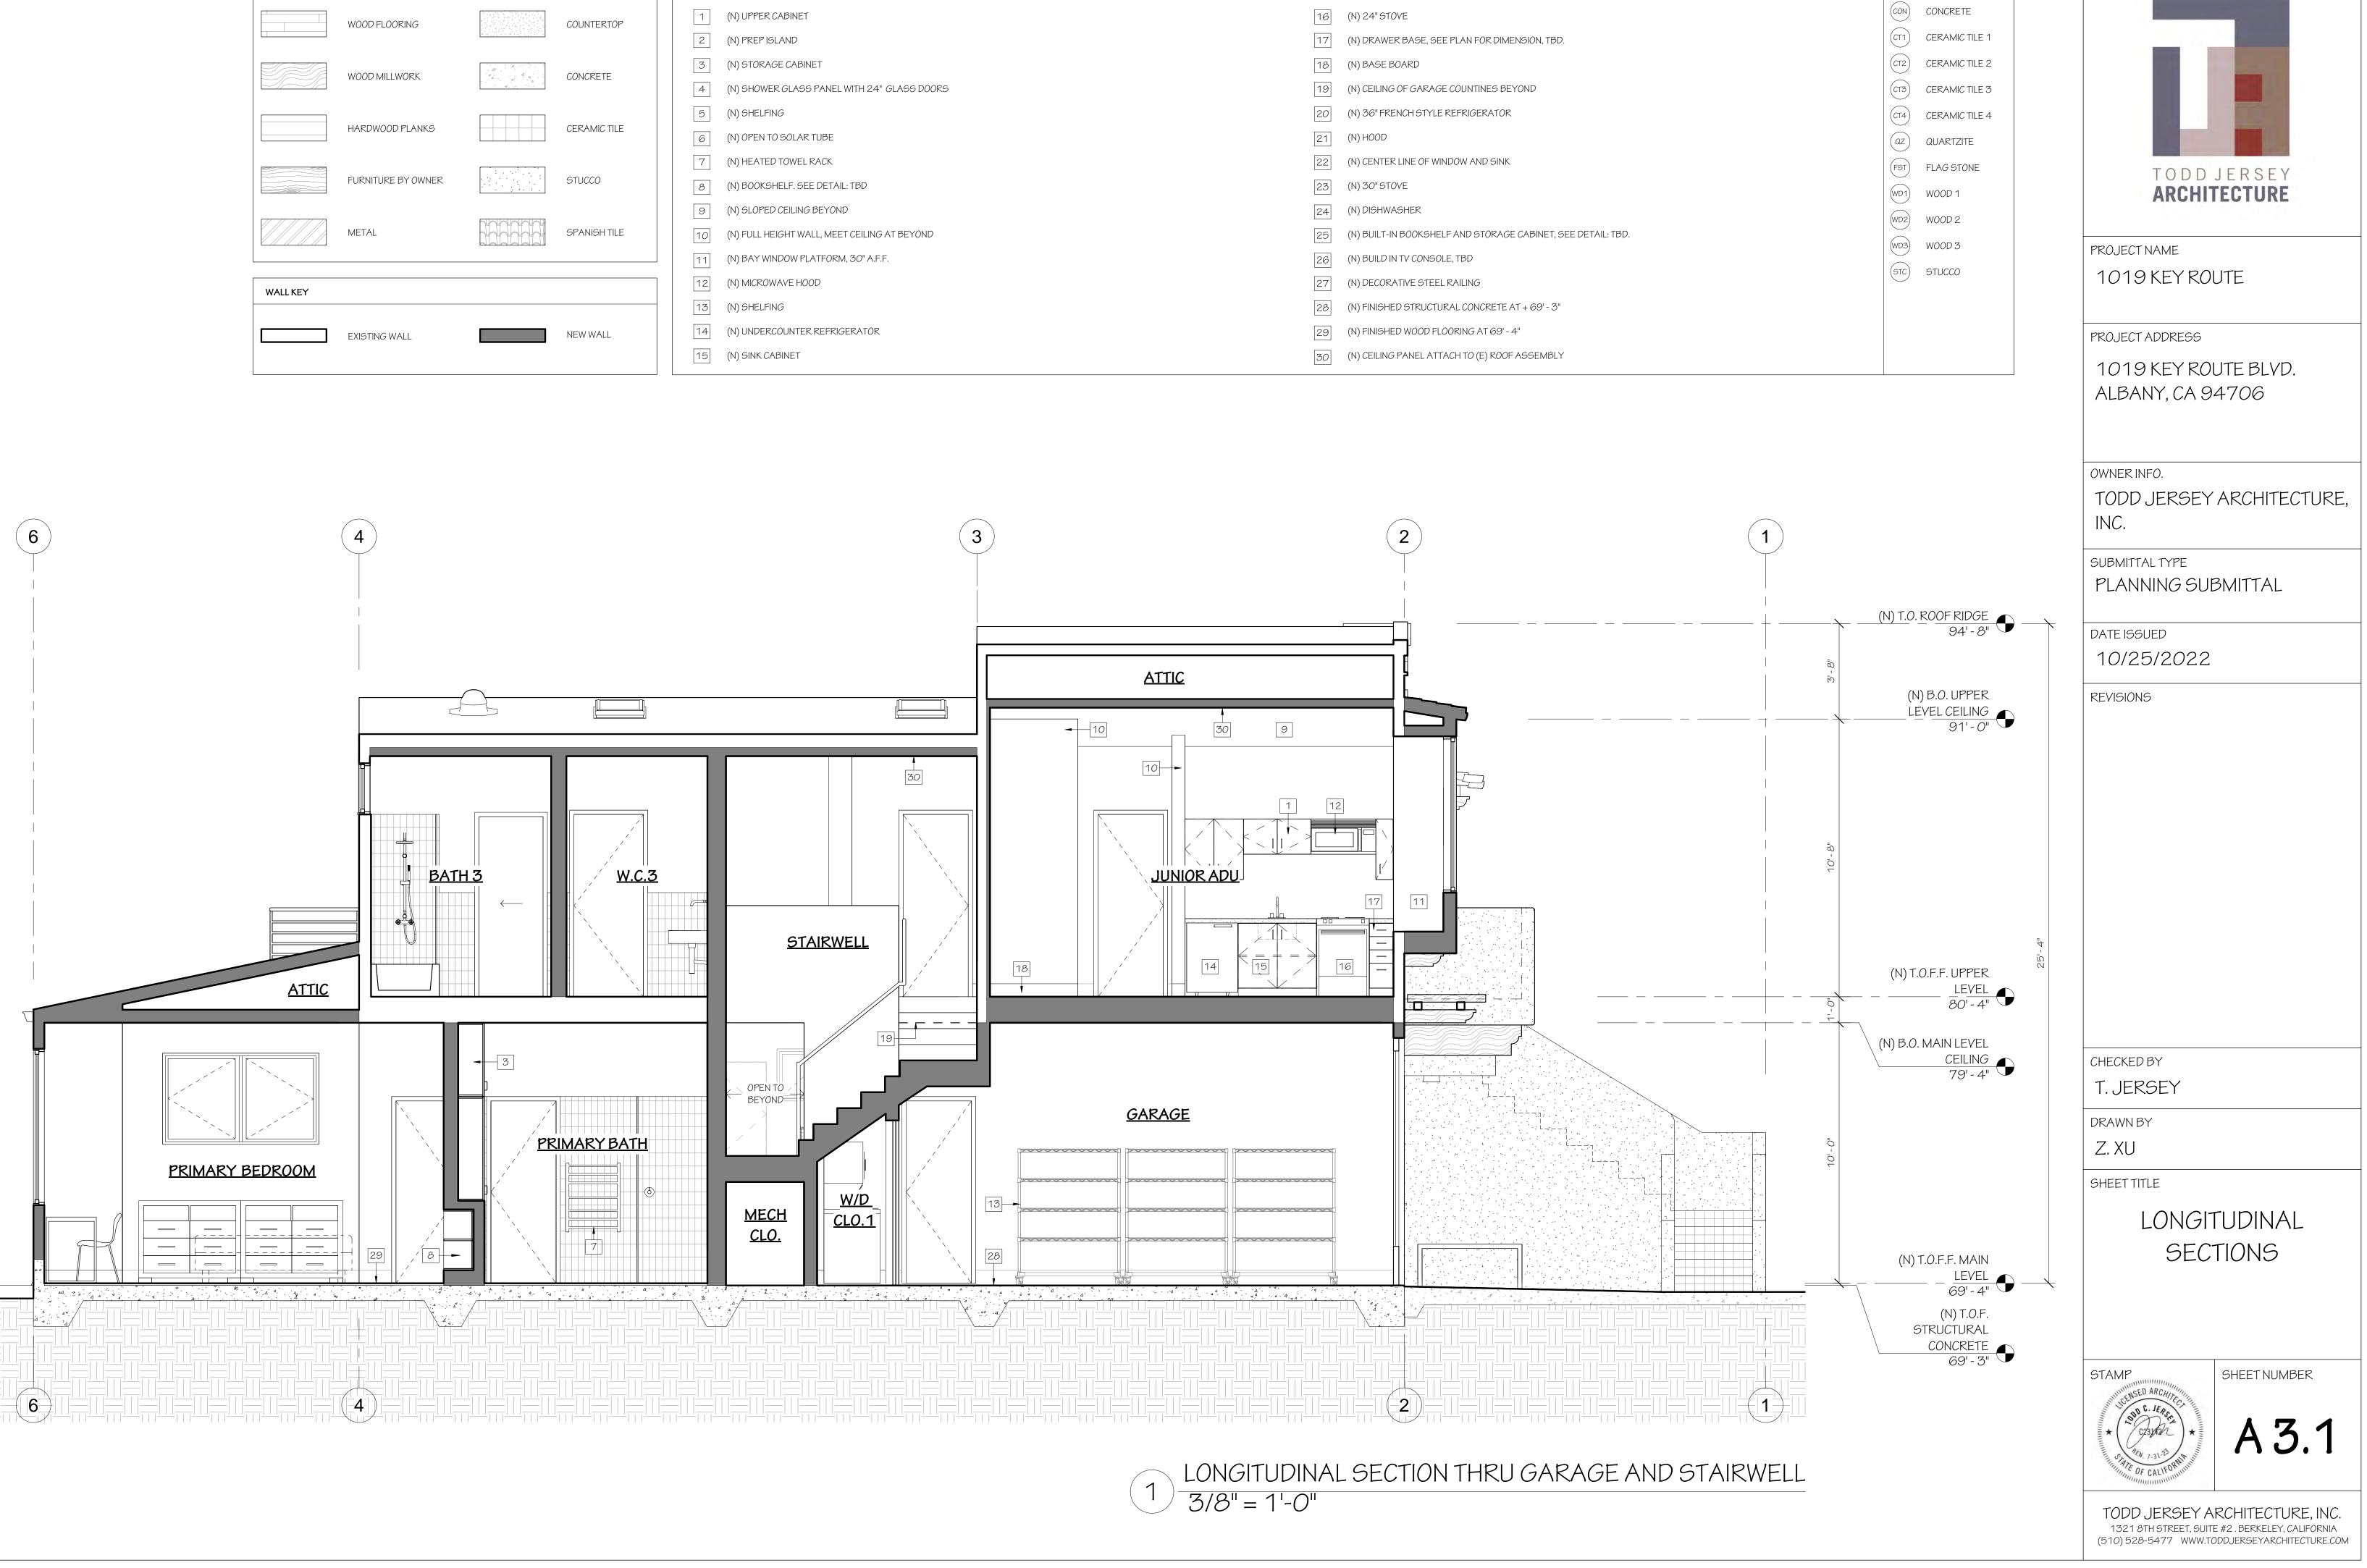


MATERIAL TEXTU	IRE		KEYN	OTES
	WOOD FLOORING	COUNTERTOP	1	(N) (N)
	WOOD MILLWORK	CONCRETE	3	(N) (N)
	HARDWOOD PLANKS	CERAMIC TILE	5	(N) (N)
	FURNITURE BY OWNER	STUCCO	7	(N) (N)
	METAL	SPANISH TILE	9	(N) (N)
			11	(N)
WALL KEY			12	(N)
			13	(N)
	EXISTING WALL	NEW WALL	14	(N)
			15	(N)

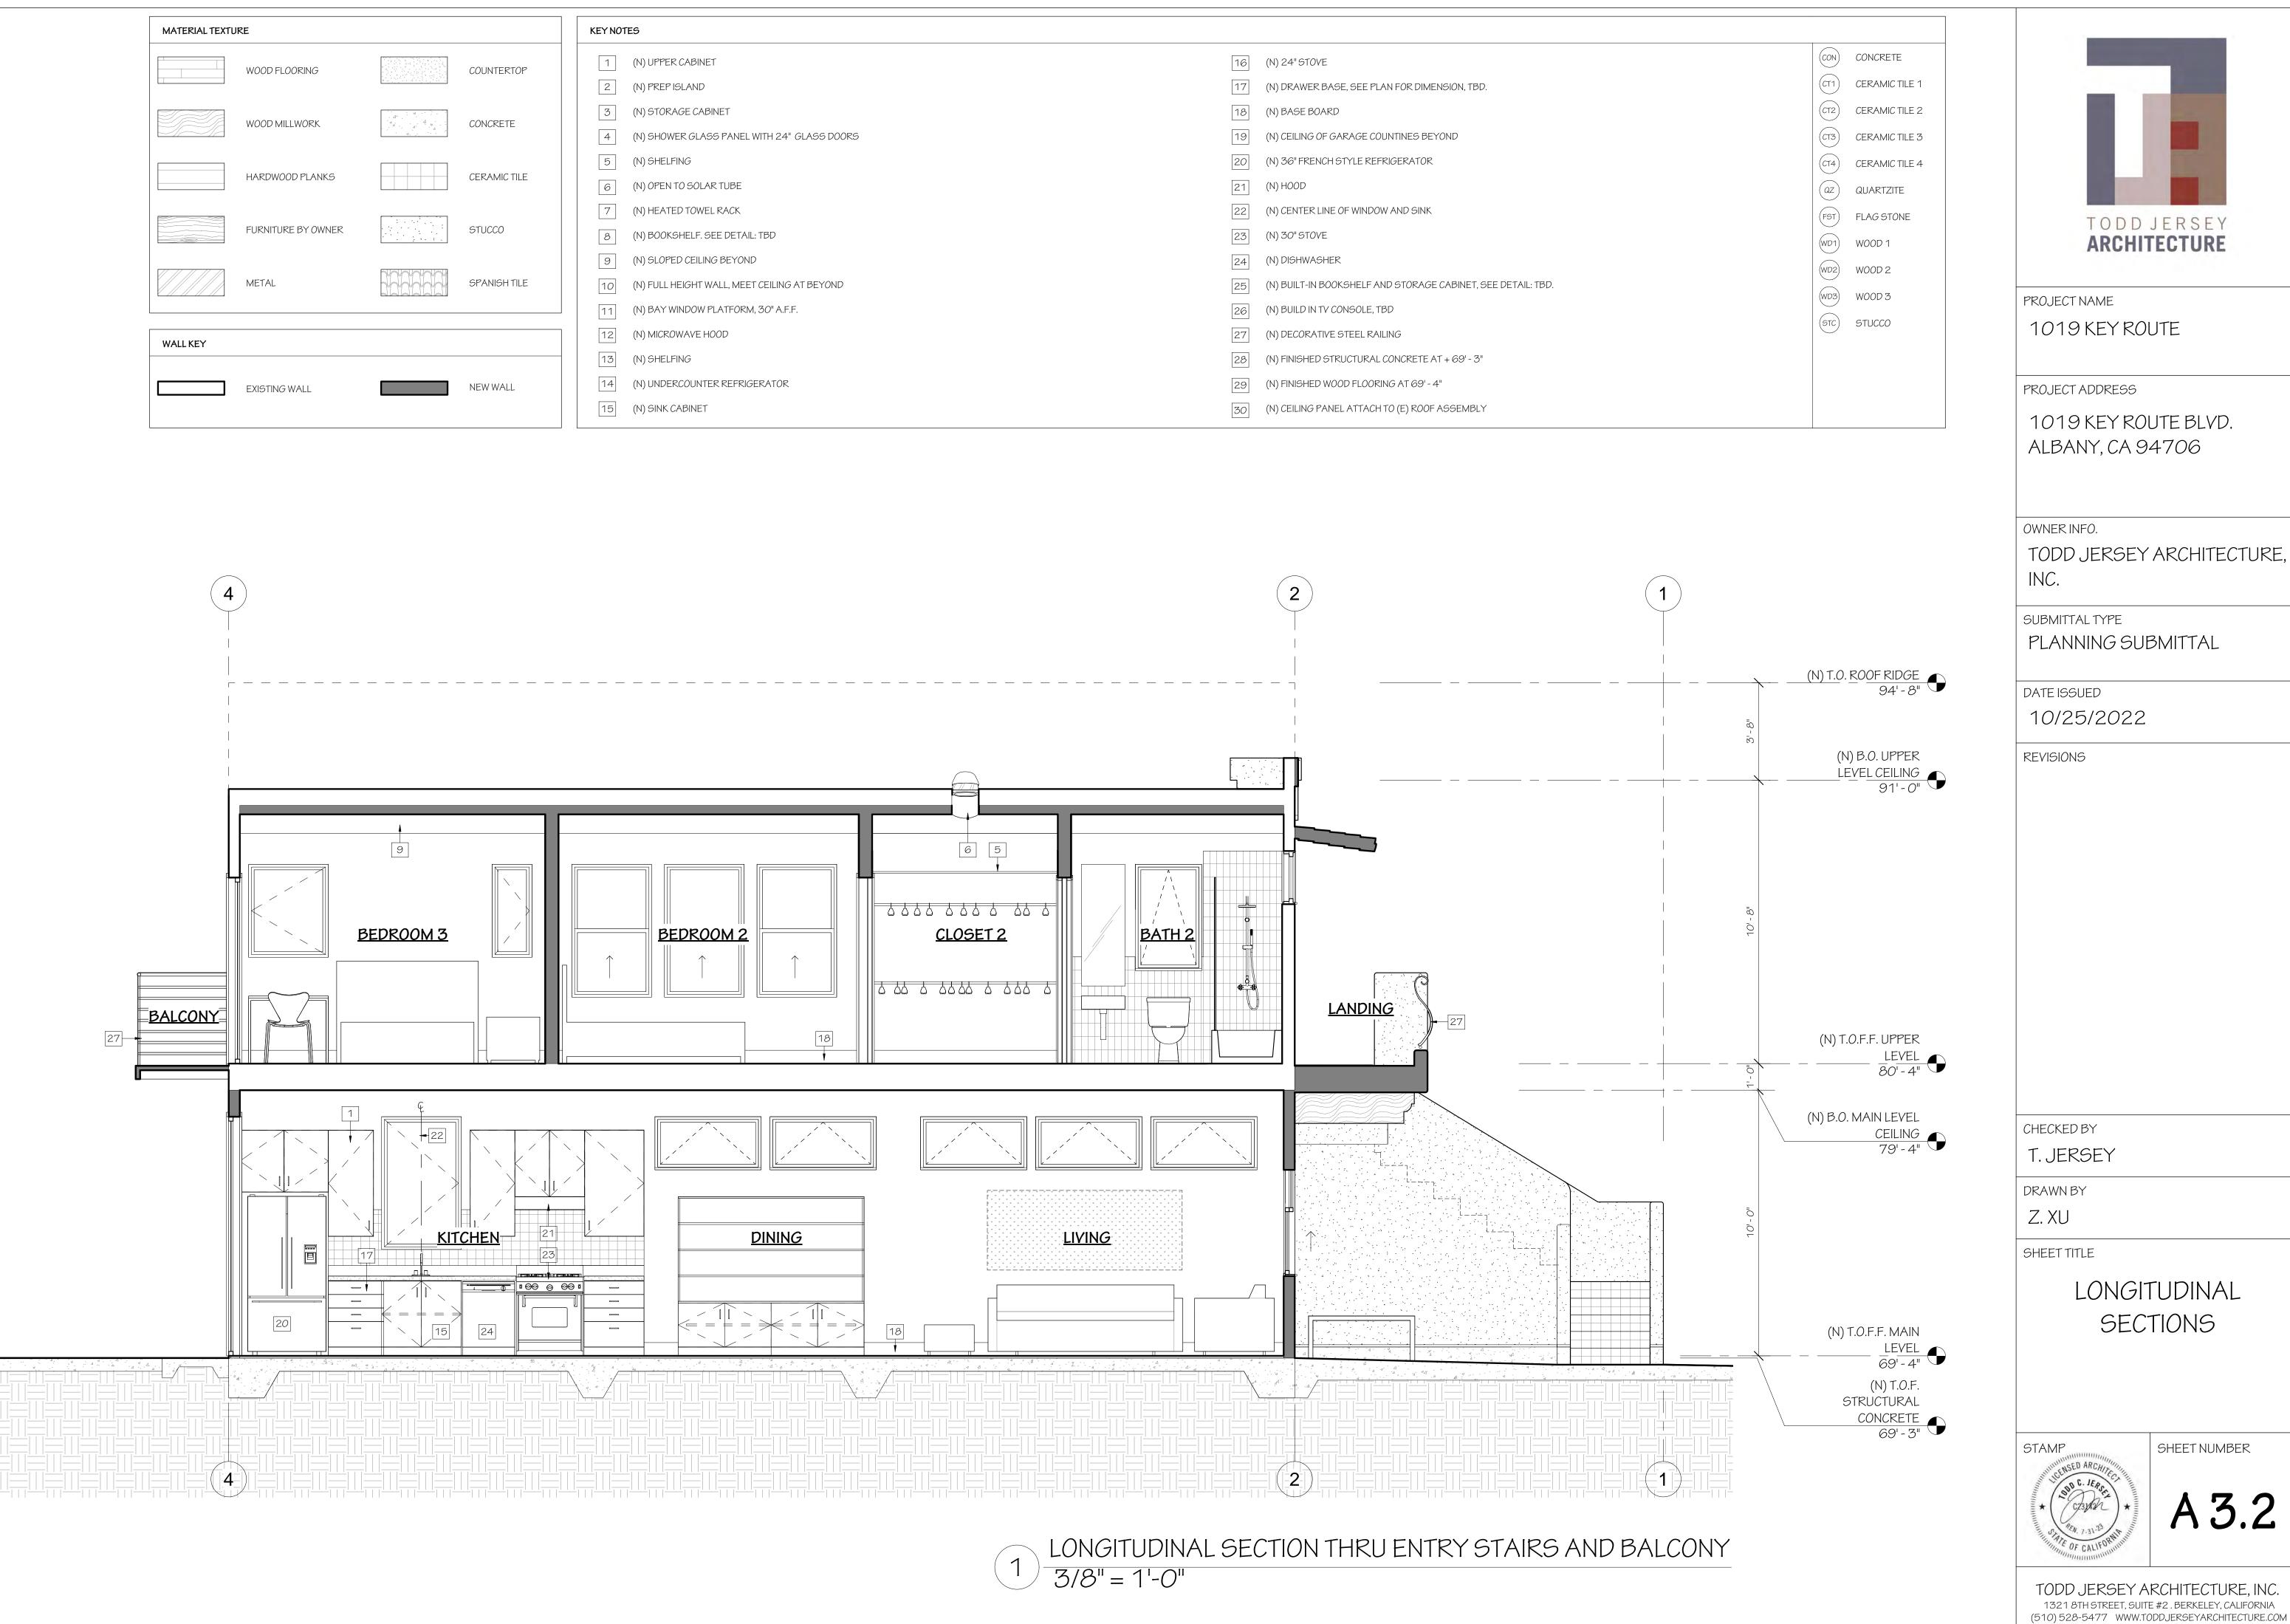

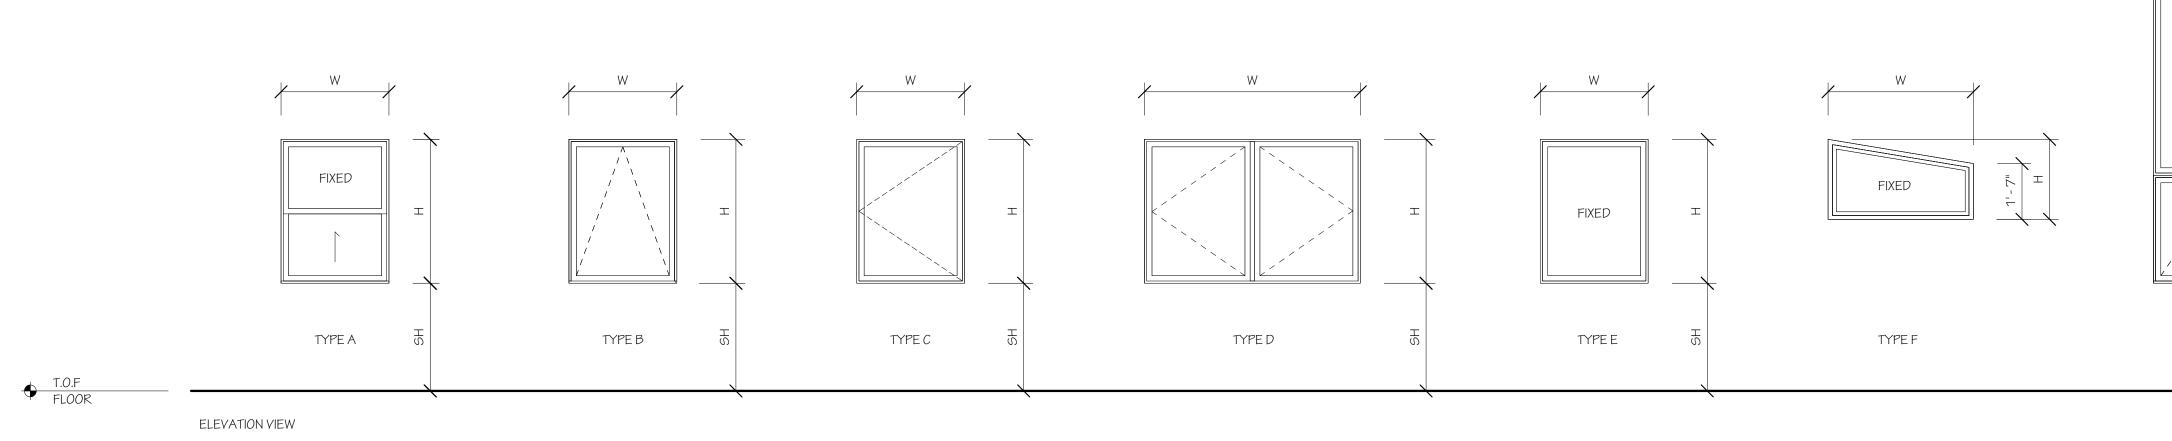



	WINDOW SCHEDULE							
SPECIA	OPERATION	GLASS	TYPE	SILL HEIGHT	HEIGHT	WIDTH	LOCATION	WINDOW TAG
	SINGLE HUNG	DUAL PANE - CLEAR TEMPERED	A	3' - 0"	5'-0"	3'-0"	LIVING	01
	AWNING	DUAL PANE - CLEAR TEMPERED	B	7' - 0"	2' - 0"	4' - <i>O</i> "	LIVING	02
	AWNING	DUAL PANE - CLEAR TEMPERED	B	7' - 0"	2' - 0"	4' - 0"	LIVING	03
	AWNING	DUAL PANE - CLEAR TEMPERED	B	7' - 0"	2' - 0"	4' - 0"	LIVING	04
	AWNING	DUAL PANE - CLEAR TEMPERED	B	7' - 0"	2' - 0"	4' - 0"	DINING	05
	AWNING	DUAL PANE - CLEAR TEMPERED	B	7' - 0"	2' - 0"	4' - 0"	DINING	06
	SINGLE CASEMENT	DUAL PANE - CLEAR TEMPERED	С	4' - 0"	5' - 0"	3'-0"	KITCHEN	07
	DOUBLE CASEMENT	DUAL PANE - CLEAR TEMPERED	D	5'-4"	3'-6"	6' - 0"	PR BEDROOM	08
	DOUBLE CASEMENT	DUAL PANE - CLEAR TEMPERED	D	3' - 0"	6' - 0"	4' - 6"	PR BEDROOM	09
	SINGLE HUNG	DUAL PANE - CLEAR TEMPERED	А	4' - O"	5' - 0"	3' - 0"	PR BEDROOM	10
	AWNING	DUAL PANE - FROSTED TEMPERED	В	5'-0"	4' - 0"	2'-6"	PRBATH	11
	FIXED	DUAL PANE - CLEAR TEMPERED	E	6' - 4"	2' - <i>O</i> "	4' - 0"	GARAGE	12
	FIXED	DUAL PANE - CLEAR TEMPERED	E	6' - 4"	2' - <i>0</i> "	4' - 0"	GARAGE	13
	AWNING	DUAL PANE - FROSTED TEMPERED	В	5'-0"	2' <i>-0</i> "	3' - <i>0</i> "	BATH 2	14
	AWNING	DUAL PANE - FROSTED TEMPERED	В	2'-6"	4' - <i>0</i> "	2'-6"	BATH 2	15
	SINGLE HUNG	DUAL PANE - CLEAR TEMPERED	А	1'-6"	5' - 0"	3' - 0"	BEDROOM 2	16
	SINGLE HUNG	DUAL PANE - CLEAR TEMPERED	А	1'-6"	5'-0"	3' - 0"	BEDROOM 2	17
	SINGLE HUNG	DUAL PANE - CLEAR TEMPERED	А	1'-6"	5'-0"	3' - 0"	BEDROOM 2	18
	SINGLE CASEMENT	DUAL PANE - CLEAR TEMPERED	С	3' - 0"	3'-6"	1'-6"	BEDROOM 3	19
	SINGLE CASEMENT	DUAL PANE - CLEAR TEMPERED	С	3' - 0"	3'-6"	3'-0"	BEDROOM 3	20
	AWNING	DUAL PANE - CLEAR TEMPERED	В	4' - 0"	3' - 0"	2' - <i>O</i> "	BEDROOM 3	21
	TRAP FIXED	DUAL PANE - CLEAR TEMPERED	F	7' - 0"	2'-3"	4' - 1"	BATH 3	22
	AWNING	DUAL PANE - FROSTED TEMPERED	В	3' - 0"	4' - 0"	3' - 0"	BATH 3	23
	AWNING	DUAL PANE - FROSTED TEMPERED	В	3' - 0"	4' - <i>0</i> "	3' - 0"	W.C.3	24
UPPER FIX W/ LOWER AWNING M	FIXED & AWNING	DUAL PANE - CLEAR TEMPERED	G	1 <i>0' -(</i> 0"	9' - 0"	4' - 0"	STAIRS	25
	FIXED & AWNING	DUAL PANE - CLEAR TEMPERED	G	1 <i>0' -\</i> 0"	9' - 0"	4' - 0"	STAIRS	26
	SINGLE HUNG	DUAL PANE - CLEAR TEMPERED	А	4' - 0"	6' - 0"	4' - 0"	JUNIOR ADU	27
	FIXED	DUAL PANE - CLEAR TEMPERED	E	4' - 0"	6' - 0"	7' - 0"	JUNIOR ADU	28
	DOUBLE CASEMENT	DUAL PANE - CLEAR TEMPERED	D	4' - 0"	6' - 0"	6' - 0''	JUNIOR ADU	29
FAC	FIXED SKYLIGHT	DUAL PANE - CLEAR TEMPERED	Н	SKYLIGHT	2'-6"(L)	1'-10"	HALL	30
FAC	FIXED SKYLIGHT	DUAL PANE - CLEAR TEMPERED	Н	SKYLIGHT	2'-6" (L)	1'-10"	HALL	31

TYPE G TYPE H		
FLOOR VIEW		
CIAL FEATURE / ACCESSORIES		
EGRESS WINDOW	CHECKED BY T. JERSEY	
	drawn by Z. XU	
EGRESS WINDOW EGRESS WINDOW EGRESS WINDOW EGRESS WINDOW		ED WINDOW EDULE
G MULLED, SILL HIEGHT BASE OFF OF T.O.F.F. MAIN LEVEL		
EGRESS WINDOW ACTORY SIZE, CURB MOUNT ACTORY SIZE, CURB MOUNT WINDOW SCHEDULE	STAMP ST	SHEET NUMBER
<u> </u> <u></u>	1321 8TH STREET, SUIT	RCHITECTURE, INC. E #2 . BERKELEY, CALIFORNIA DDDJERSEYARCHITECTURE.COM

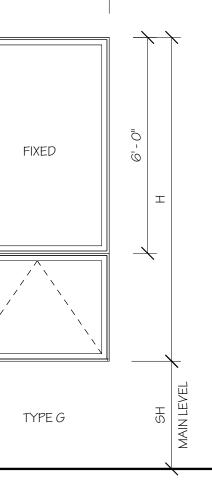

W

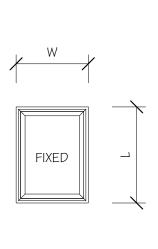

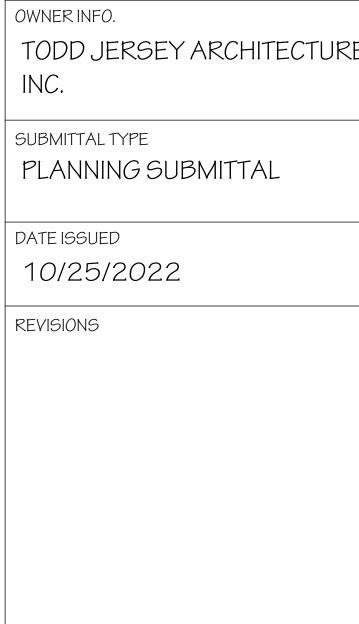


OWNER INFO. TODD JERSEY ARCHITECTURE, INC.


PROJECT ADDRESS

1019 KEY ROUTE BLVD.

ALBANY, CA 94706

PROJECT NAME 1019 KEY ROUTE

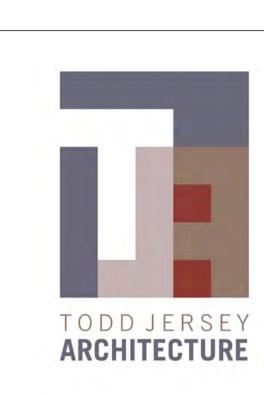

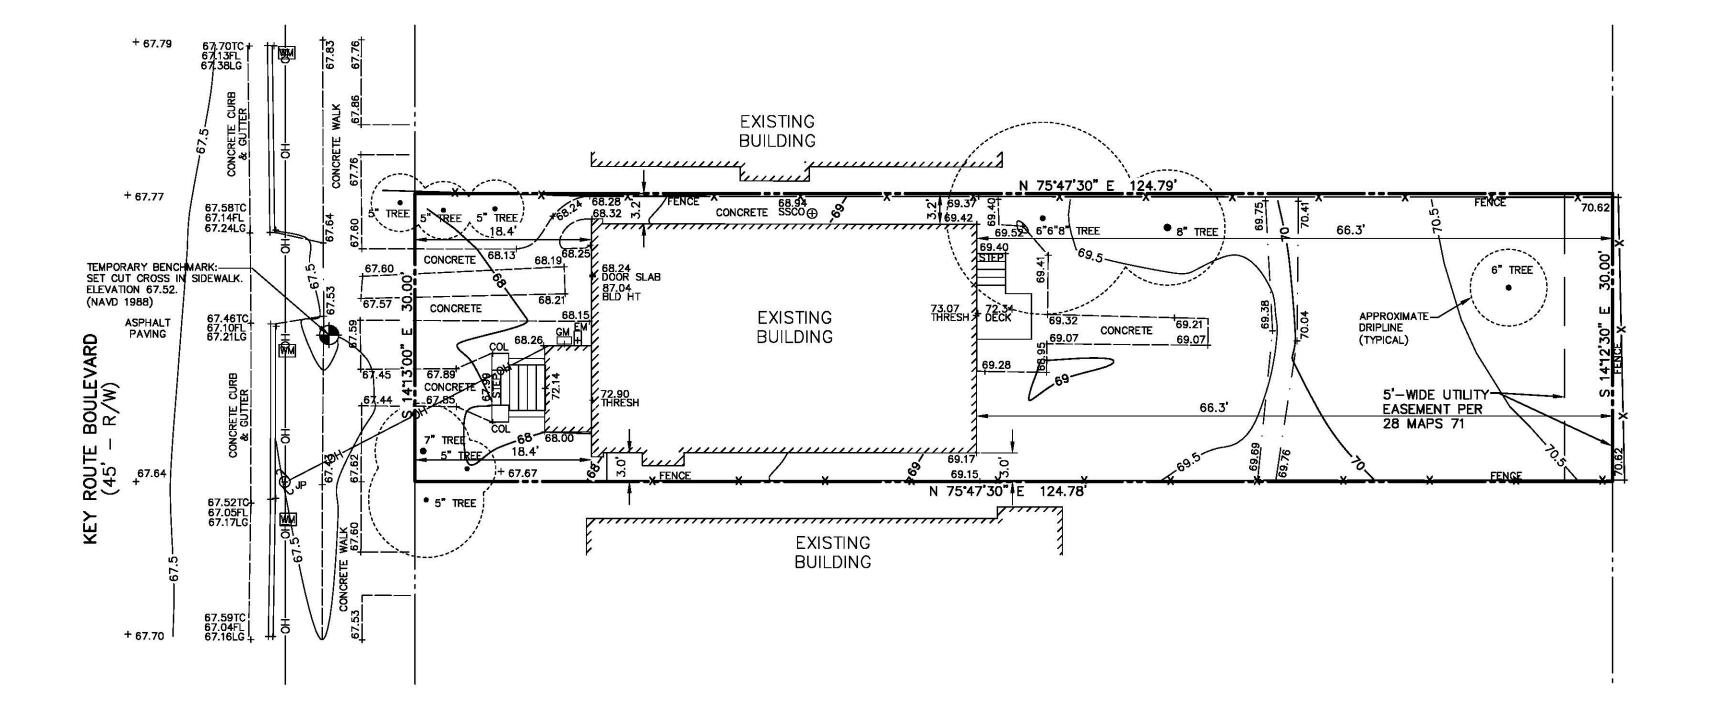

<u>LEGEND</u>

1		FROFERITE
COL		COLUMN
EM		ELECTRIC ME
FL		FLOWLINE
GM		GAS METER
Ъ₫		JOINT UTILIT
LG		LIP OF GUTT
SSCO		SANITARY SE
TC		TOP OF CUR
THRESH		THRESHOLD
WM		WATER METE
	●12" TREE	TREE W/ SIZ
—x—	X	FENCE

EASEMENT NOTE:

EASEMENT SHOWN IS BASED ON A REVIEW OF 28 MAPS 71. OTHER EASEMENTS, IF ANY, ARE NOT INDICATED HEREON.

FLOOD ZONE NOTE:

THE SUBJECT PROPERTY LIES ENTIRELY WITHIN FLOOD ZONE "X", BASED ON FLOOD INSURANCE RATE MAP 06001C0018H, DATED DECEMBER 21, 2018.

UTILITY NOTE:

THE UTILITIES EXISTING ON THE SURFACE AND SHOWN ON THIS DRAWING HAVE BEEN LOCATED BY FIELD SURVEY. UNDERGROUND UTILITIES ARE NOT SHOWN ON THIS DRAWING.

LOT AREA:


= 3,744 SQ. FT. \pm = 0.086 ACRES \pm



(IN FEET 1 inch = 10

SC	ALE		
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[)			
f	t.		

				DATE:		
				ΒY:		
				DESCRIPTION		
				REV.		
* 100	HAND HAND					
	DAINS LAND SURVEYING rdains@dainslandsurveying.net (650) 743-0831					
PREPARED FOR:		JEROME RAINEY				
		<u>-</u>		CALIFORNIA		
		IUIS KET ROUTE BOULEVARD A.P.N. 65-2644-53	LOT 89, 28 MAPS 71	ALAMEDA COUNTY		
				ALBANY		
	DRAWN BY: RJD					
	DESIGNED BY: CHECKED BY: RJD					
	SCALE: 1"=10'					
	DATE: 05/31/22					
		project no. 22-1147				
PR			47			

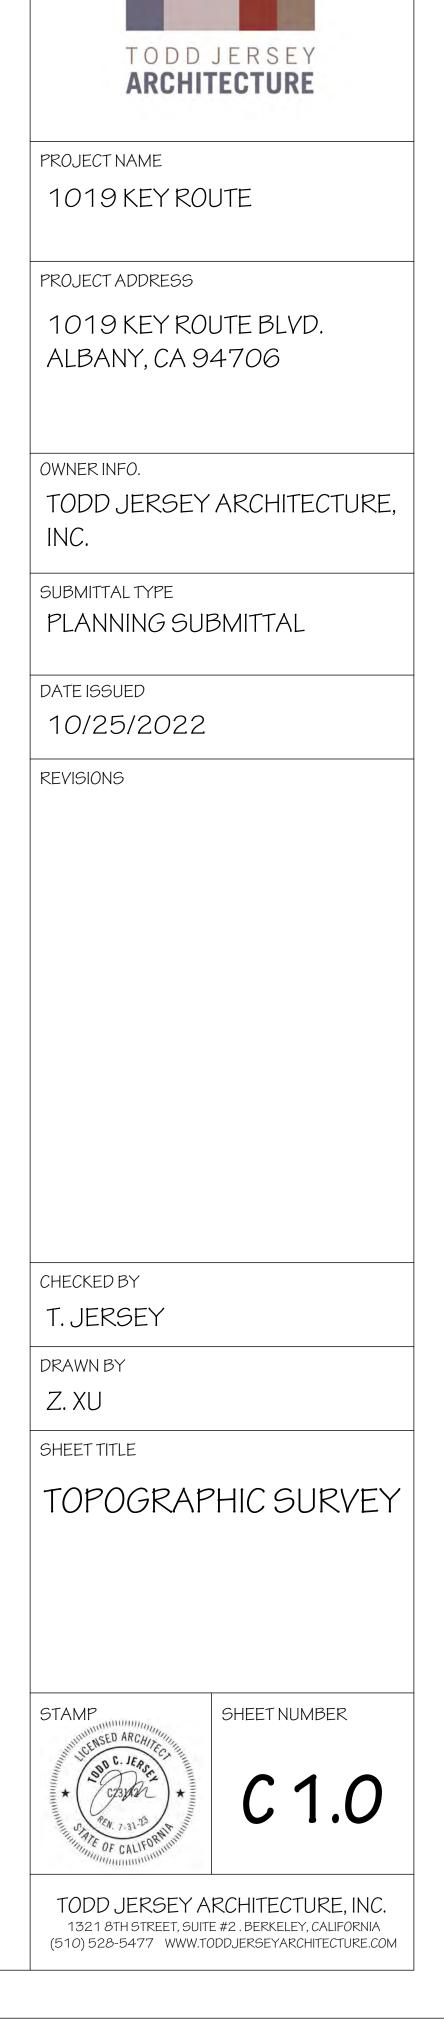

PROPERTY LINE

CTRIC METER

METER INT UTILITY POLE OF GUTTER NITARY SEWER CLEANOUT OF CURB

TER METER EE W/ SIZE